GENERAL NOTES

- 1. DRAWINGS CONTAINED HEREIN WERE DEVELOPED FROM FIELD OBSERVATIONS AND AVAILABLE INFORMATION AND MAY NOT INDICATE ACTUAL CONDITIONS IN DETAIL OR DIMENSION. THE CONTRACTOR IS RESPONSIBLE FOR DETERMINING ACTUAL EXISTING CONDITIONS PRIOR TO FABRICATION OR BEGINNING ANY WORK. SHOULD CONDITIONS BE DISCOVERED THAT PREVENT EXECUTION OF THE WORK AS INDICATED, THE CONTRACTOR SHALL NOTIFY THE ENGINEER IMMEDIATELY IN WRITING AND AWAIT DIRECTION FROM THE ENGINEER BEFORE PROCEEDING WITH WORK.
- 2. THE PUMP STATION SHALL REMAIN IN OPERATION DURING CONSTRUCTION, UNLESS APPROVED BY THE TOWN IN ACCORDANCE WITH SPECIFICATION SECTION 01520.
- 3. ALL WORK SHALL BE COORDINATED WITH BRIAN BAILEY, TOWN OF LEESBURG UTILITY PLANT MANAGER.
- 4. PRIOR TO BEGINNING ANY WORK, THE CONTRACTOR SHALL SUBMIT A PLANNED SEQUENCE OF CONSTRUCTION, IN ACCORDANCE WITH SPECIFICATION SECTION 01520

CATTAIL BRANCH SPS UPGRADES LEESBURG, VIRGINIA




TOWN OF LEESBURG
DEPARTMENT OF PUBLIC WORKS
CONTRACT NO. 500640-FY17-23



 $\frac{\text{VICINITY MAP}}{1" = 400'}$

			-
2	ISSUED FOR BID	3/17	JTH
1	90% SUBMITTAL	6/16	JTH
10	ISSUED FOR	DATE	BY

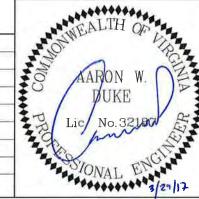



DESIGNED BY	MB
DRAWN BY	MRB
CHECKED BY	JTH
APPROVED BY	AWD





PROJECT NO. 31111-020	CATTAIL BRANCH SPS LEESBURG, VIRGINIA	G-1
DATE:	GENERAL	SHEET
MARCH 2017	COVER, GENERAL NOTES, AND SHEET INDEX	1 OF 27


INDEX OF DRAWINGS						
SHEET NO	DWG NO	DESCRIPTION				
GENERAL						
1 2	G-1 G-2	COVER, GENERAL NOTES, AND SHEET INDEX ABBREVIATIONS, LEGEND, AND SYMBOLS				
CIVIL						
3	C-1 C-2	EXISTING SITE PLAN DETAILS				
MECHANIC	AL					
5 6 7 8 9 10 11 12 13 14	M-1 M-2 M-3 M-4 M-5 M-6 M-7 M-8 M-9 M-10 M-11	EXISTING PLAN — UPPER LEVEL EXISTING PLAN — INTERMEDIATE LEVEL EXISTING PLAN — LOWER LEVEL EXISTING PLAN — SECTIONS DEMOLITION PLAN — UPPER LEVEL DEMOLITION PLAN — INTERMEDIATE LEVEL DEMOLITION PLAN — LOWER LEVEL DEMOLITION PLAN — SECTIONS INTERMEDIATE LEVEL PLAN LOWER LEVEL PLAN SECTIONS				
ELECTRICA	L					
16 17 18 19 20 21 22 23 24	E-1 E-2 E-3 E-4 E-5 E-6 E-7 E-8 E-9	LEGEND, SYMBOLS, AND ABBREVIATIONS ONE—LINE DIAGRAMS & RISERS ONE—LINE DIAGRAMS & RISERS POWER PANEL SCHEDULE CONTROL SCHEDULE POWER SCHEDULE UPPER LEVEL PLAN LOWER LEVEL PLAN ELECTRICAL DETAILS				
INSTRUME	NTATION					
25 26 27	-1 -2 -3	LEGEND, SYMBOLS, AND ABBREVIATIONS P&ID P&ID				

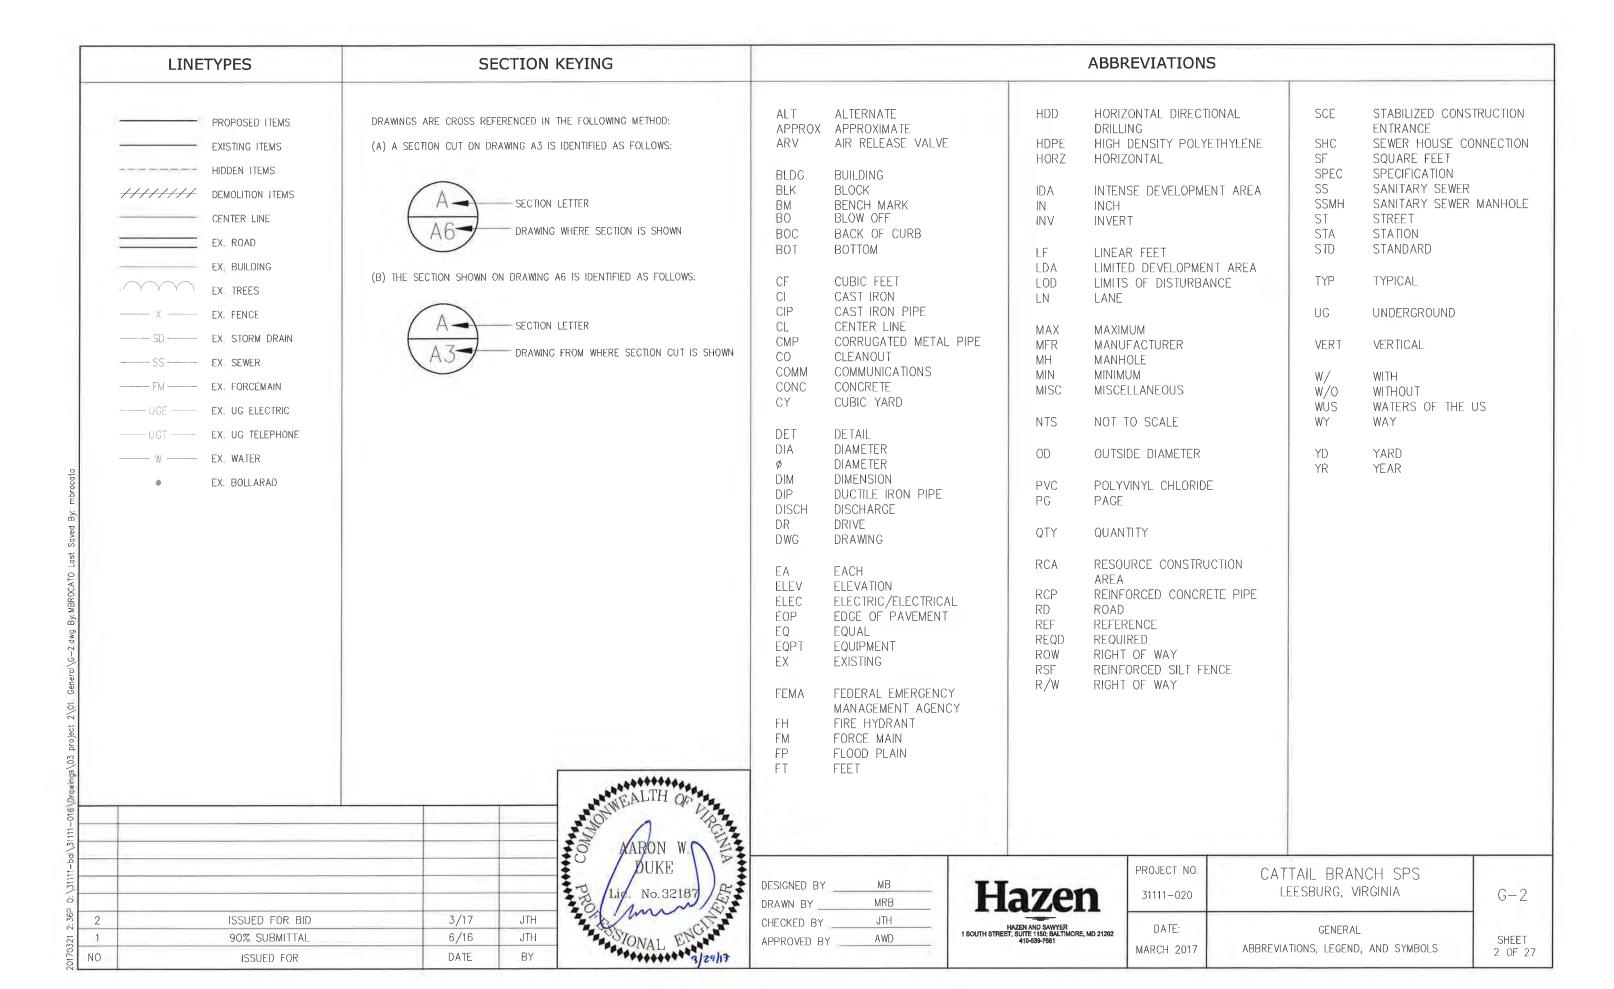

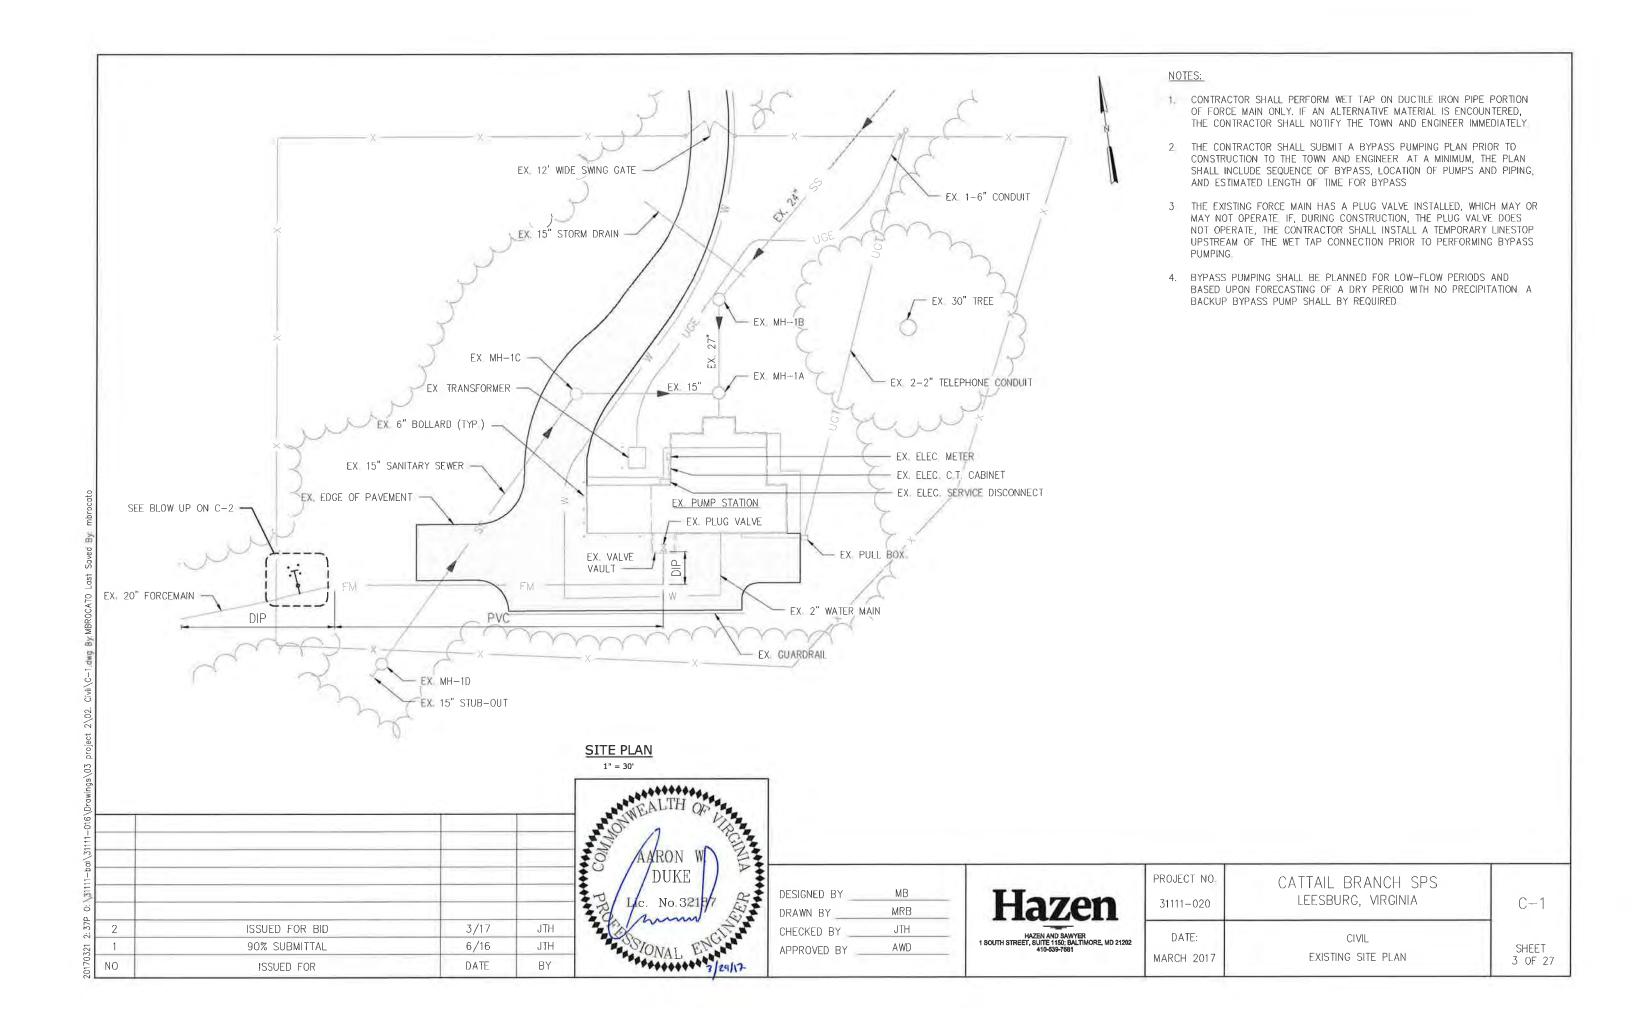


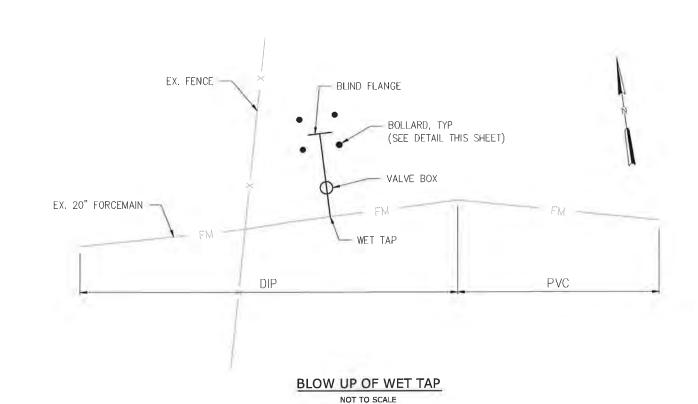

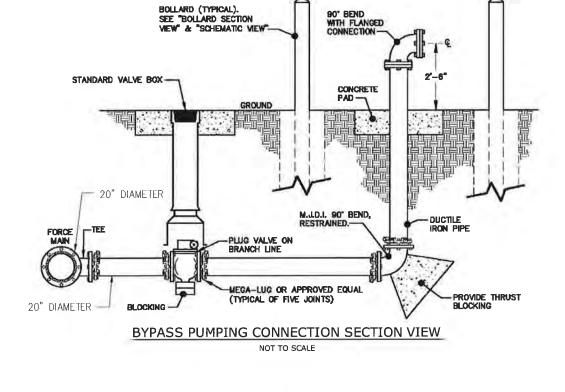

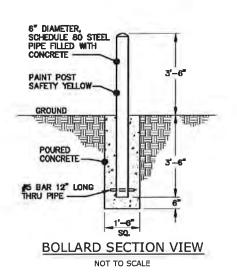


2	ISSUED FOR BID	3/17	JTH
1	90% SUBMITTAL	6/16	JTH
10	ISSUED FOR	DATE	BY

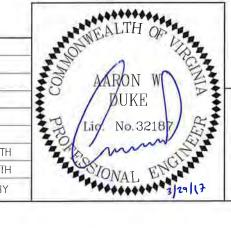



MB
MRB
JTH
AWD


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HAZEN AND SAWYER 1 SOUTH STREET, SUITE 1150; BALTIMORE, MD 21202 410-539-7681


PROJECT NO 31111-020	CATTAIL BRANCH SPS LEESBURG, VIRGINIA	C-2
DATE:	CIVIŁ	SHEET
MARCH 2017	DETAILS	4 OF 27

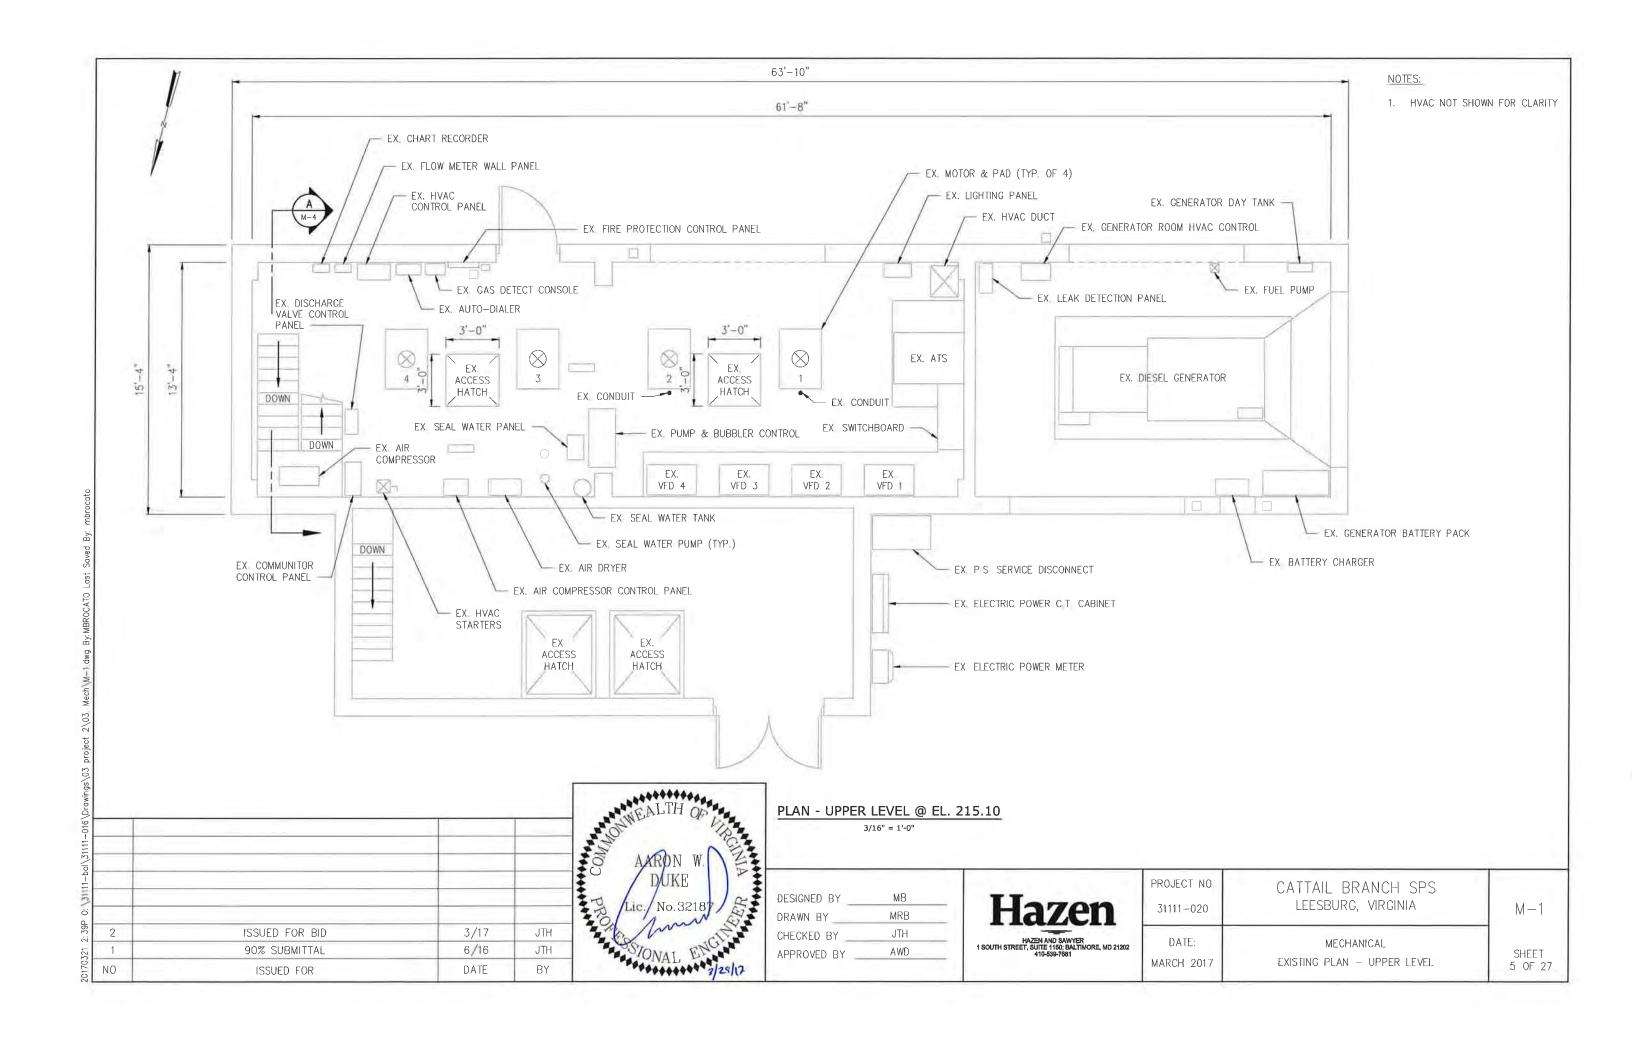


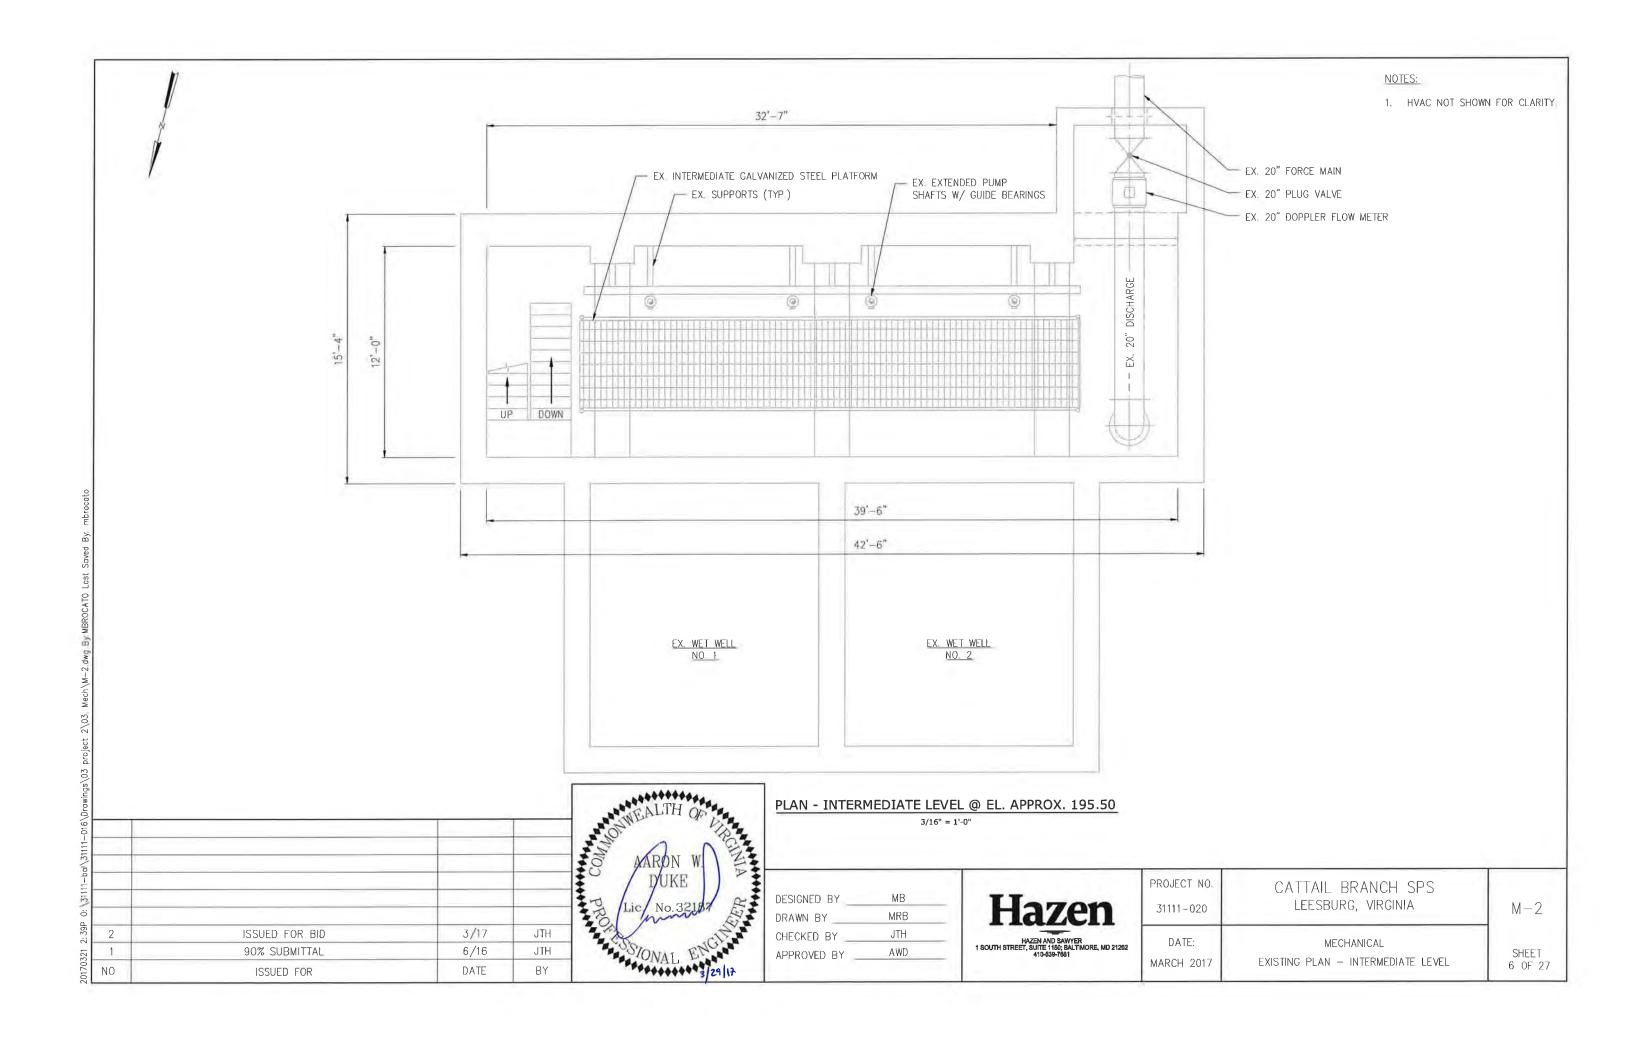


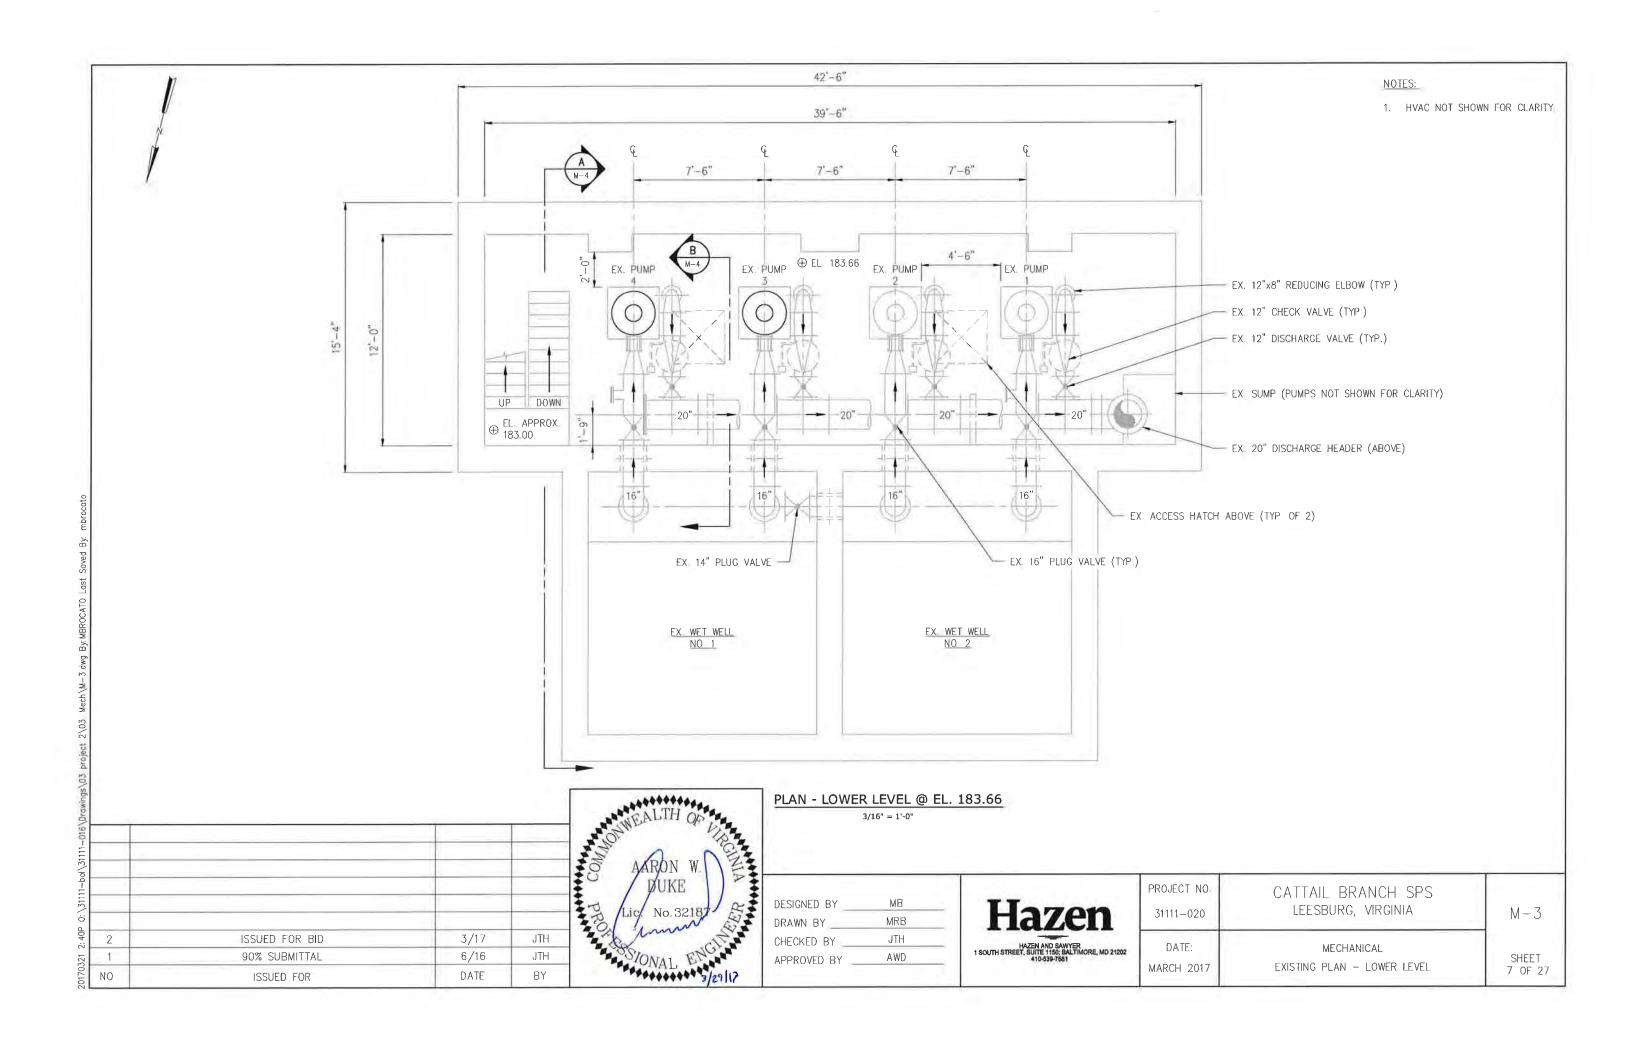


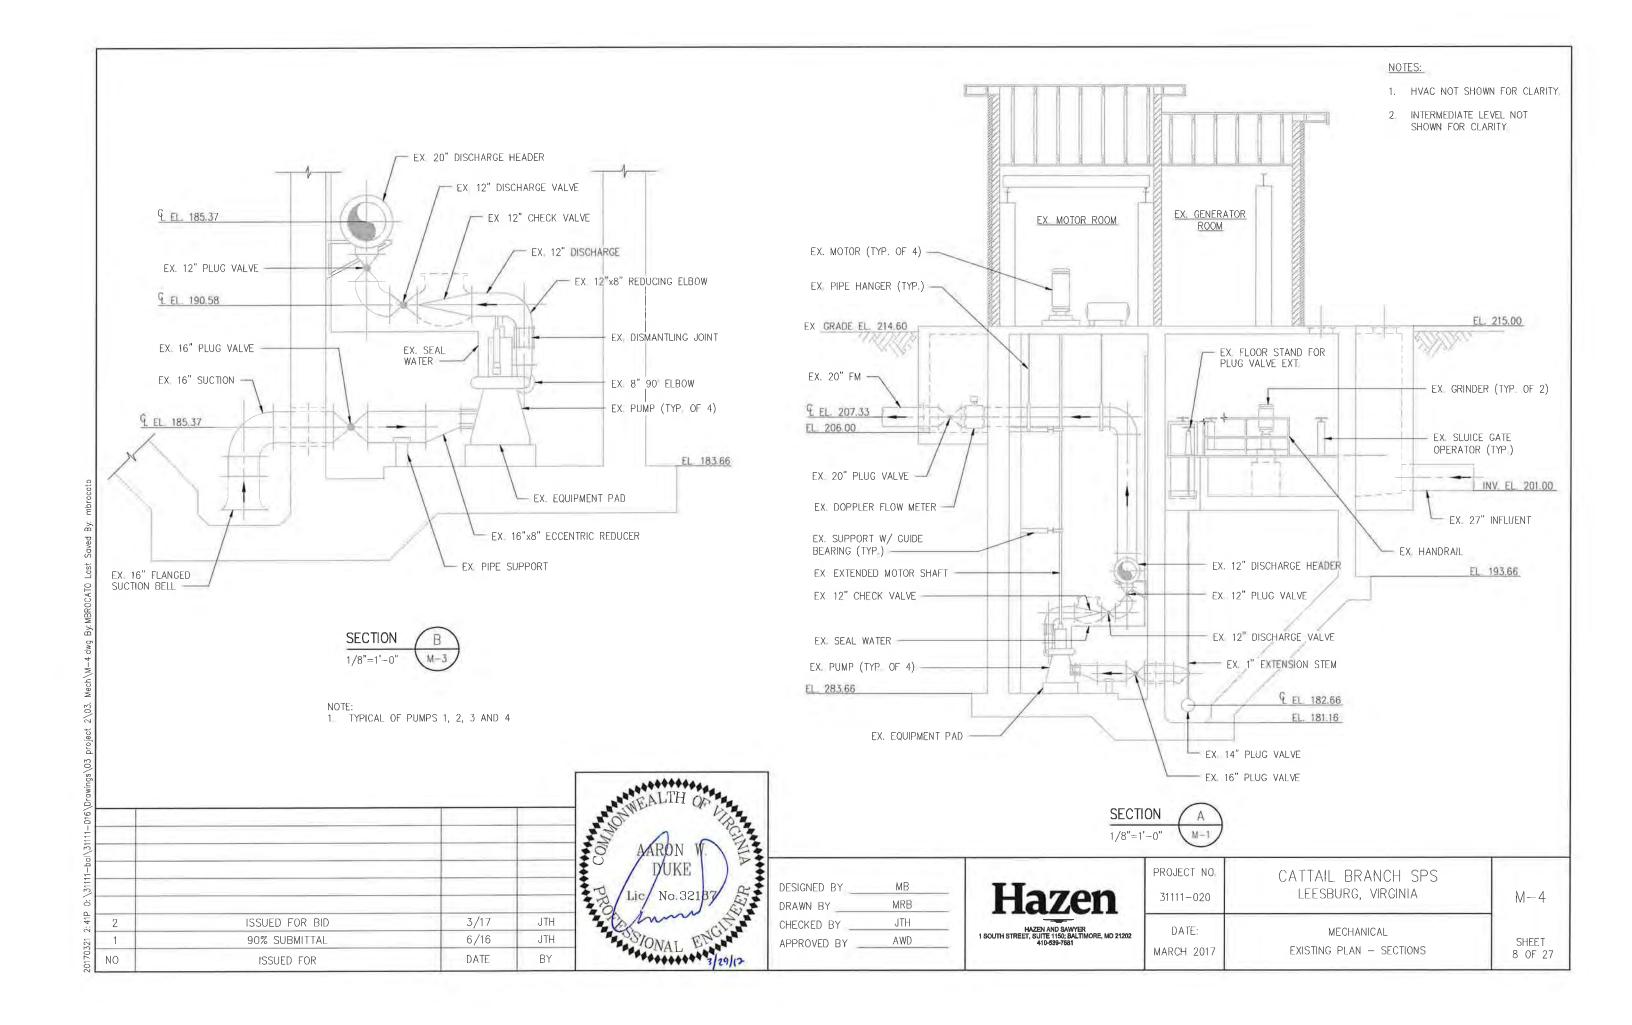


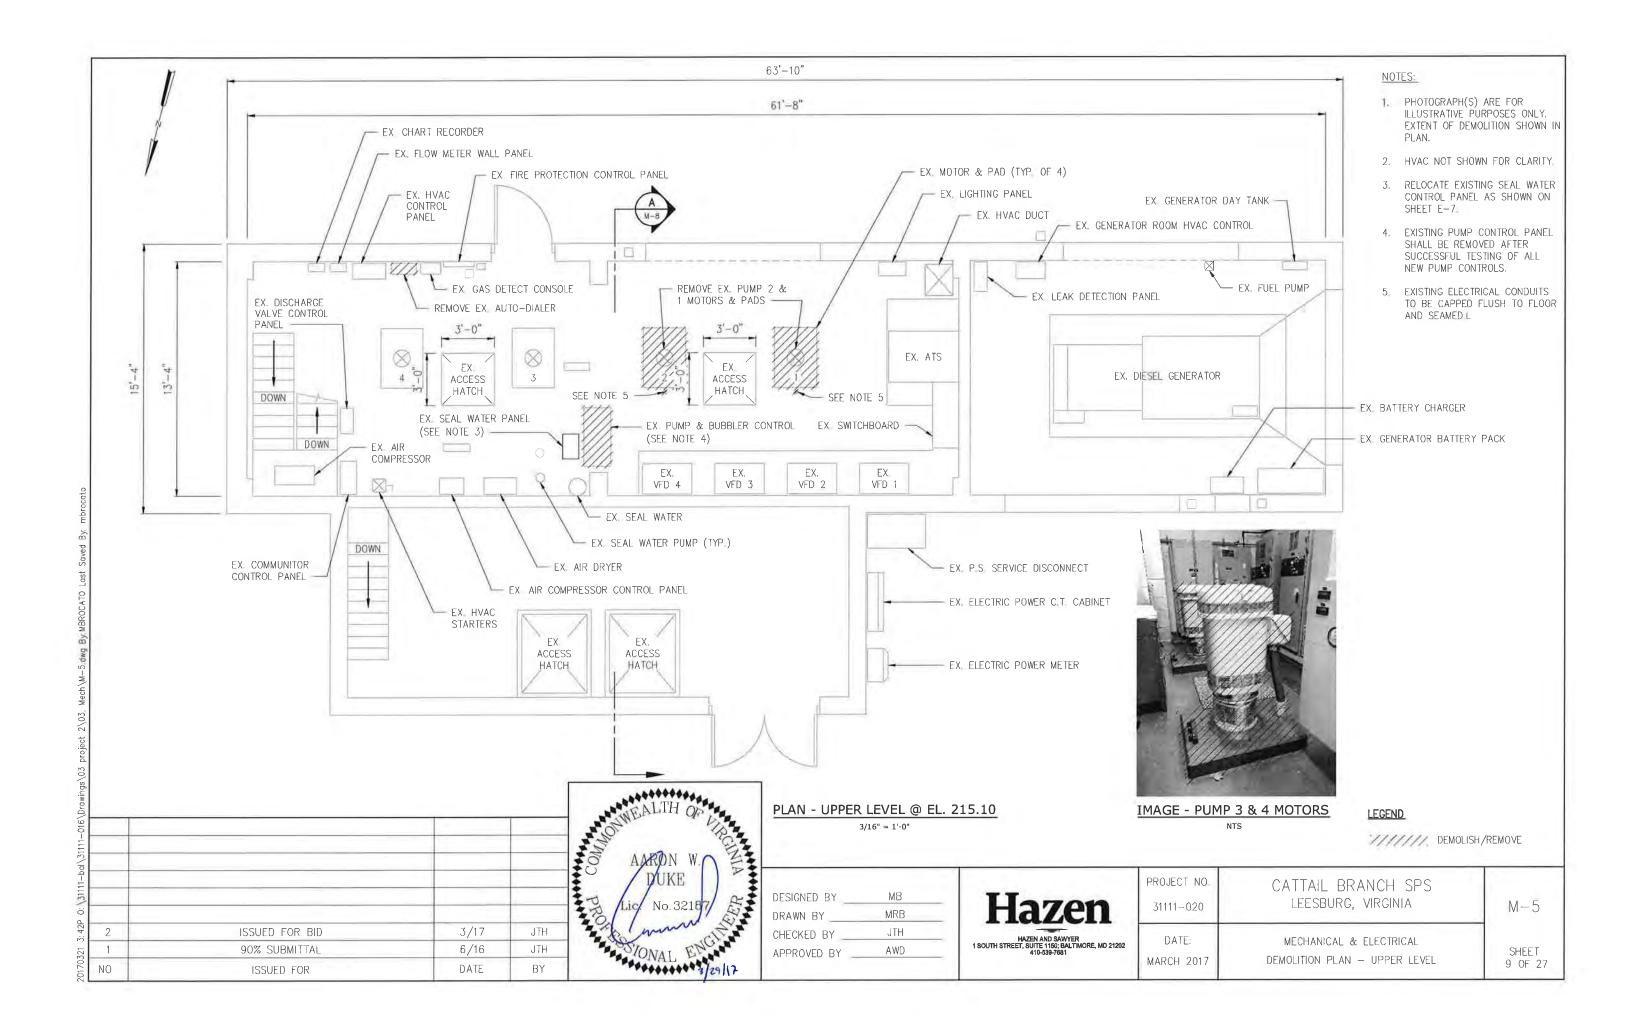


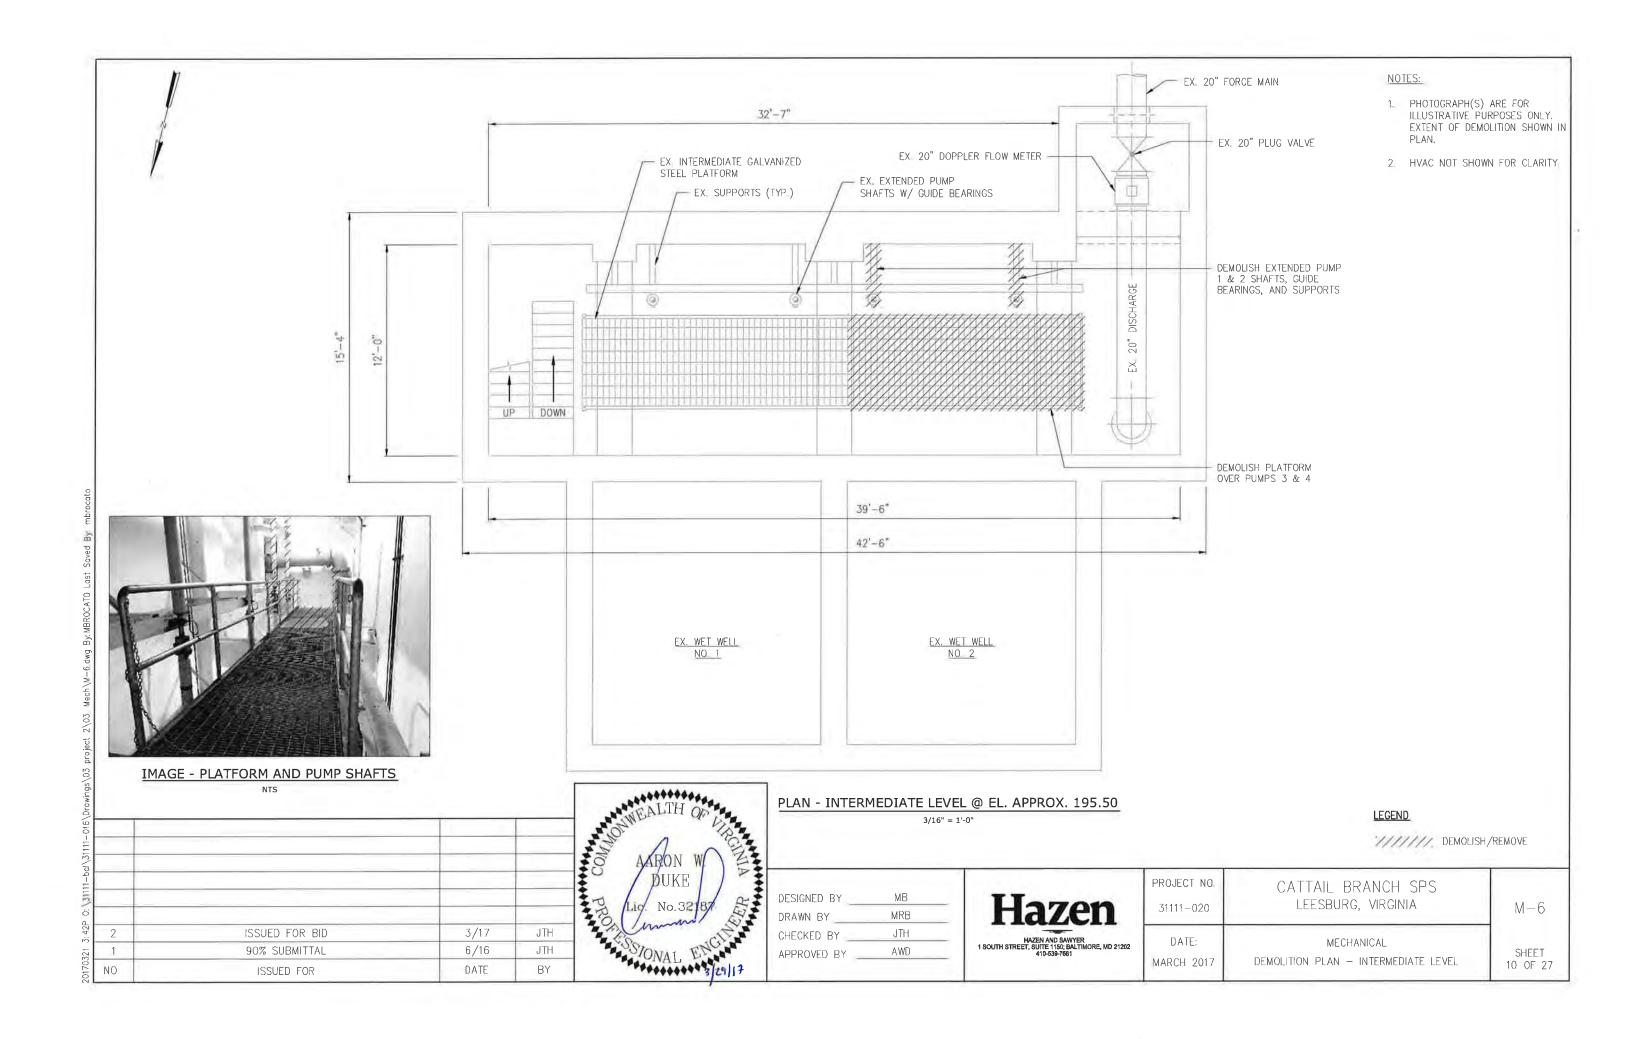


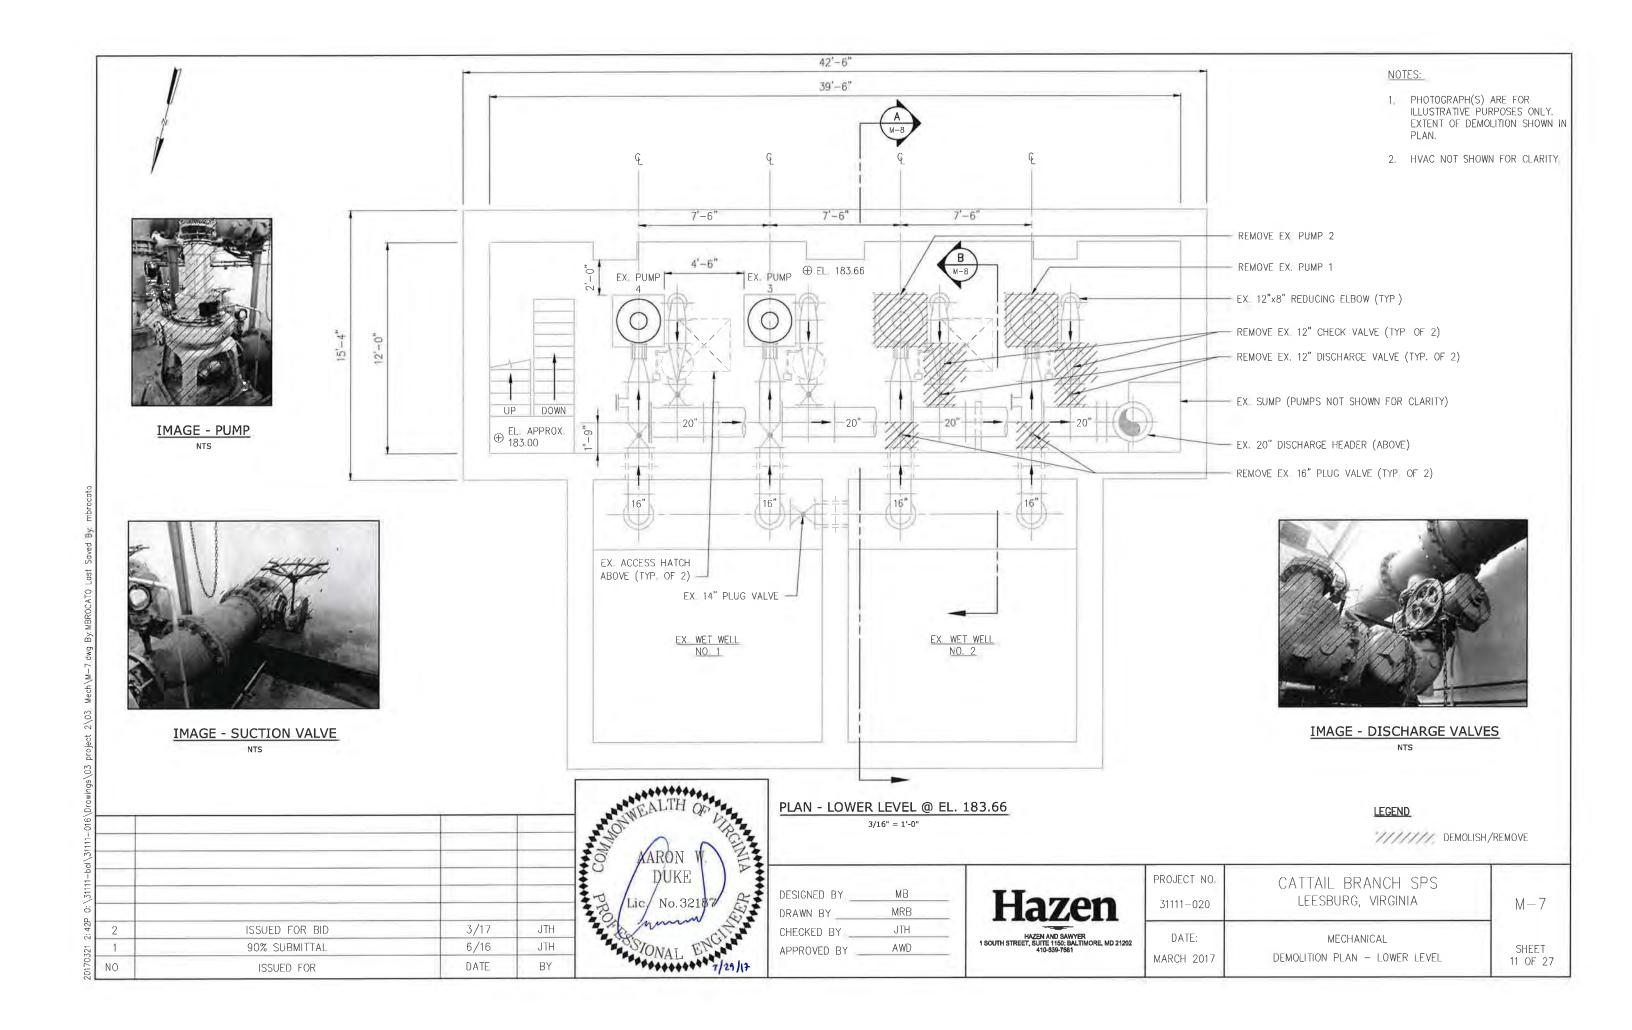


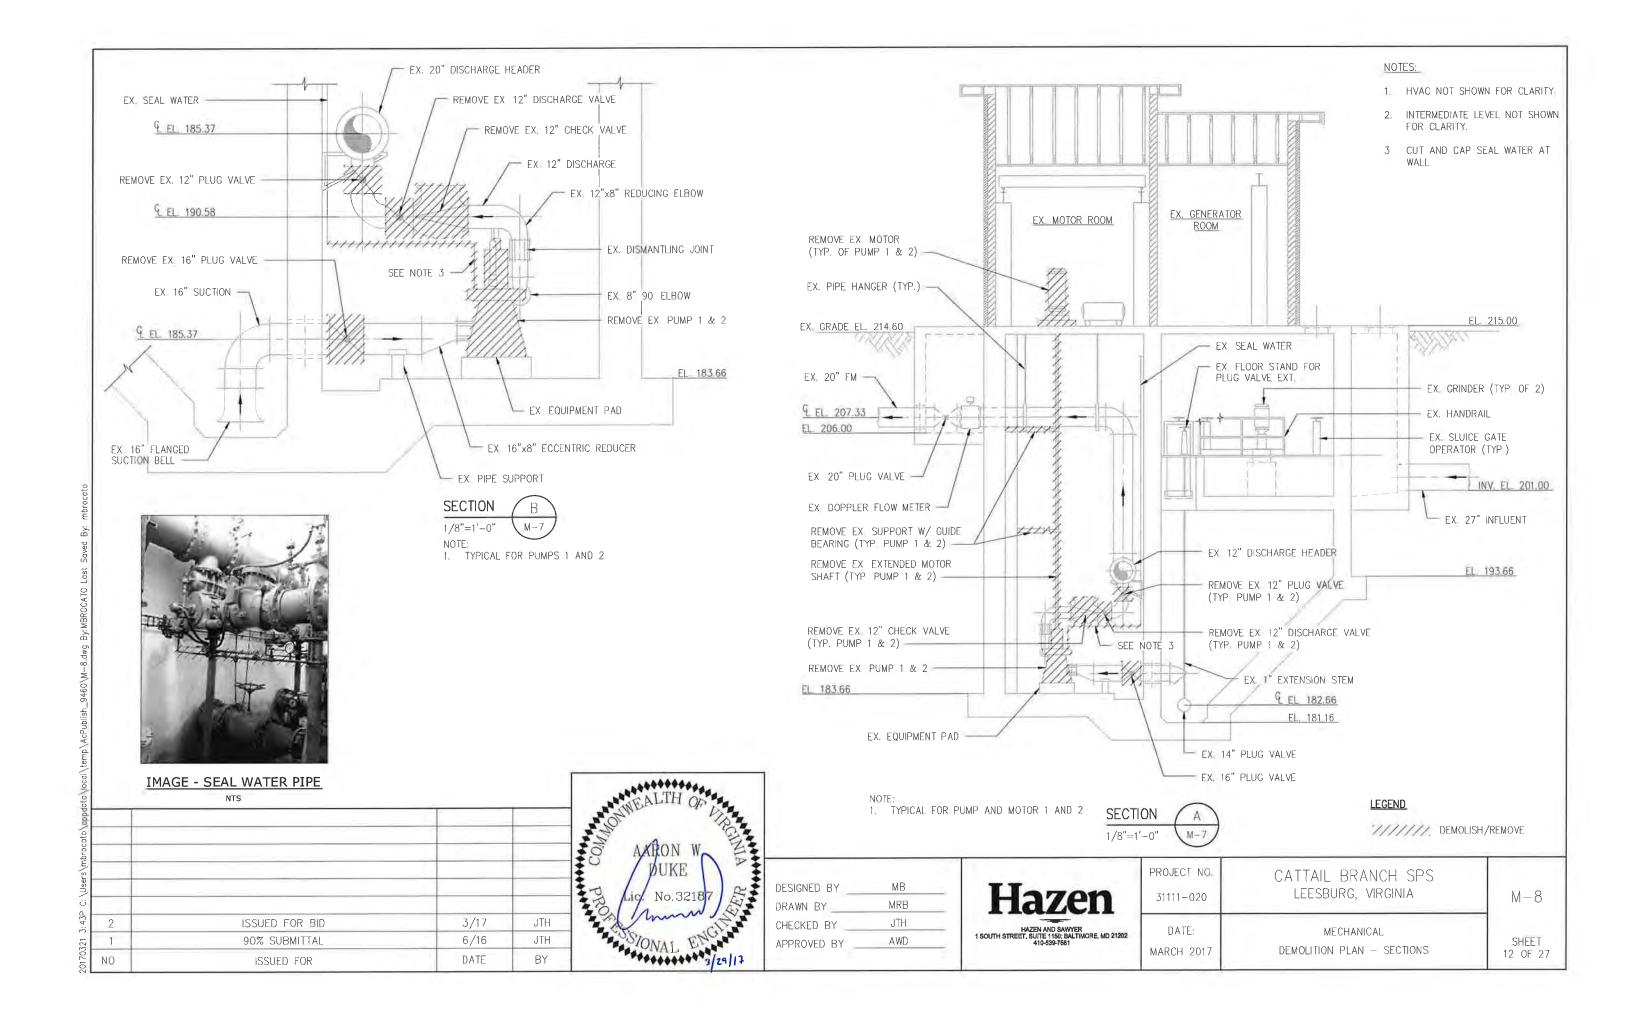


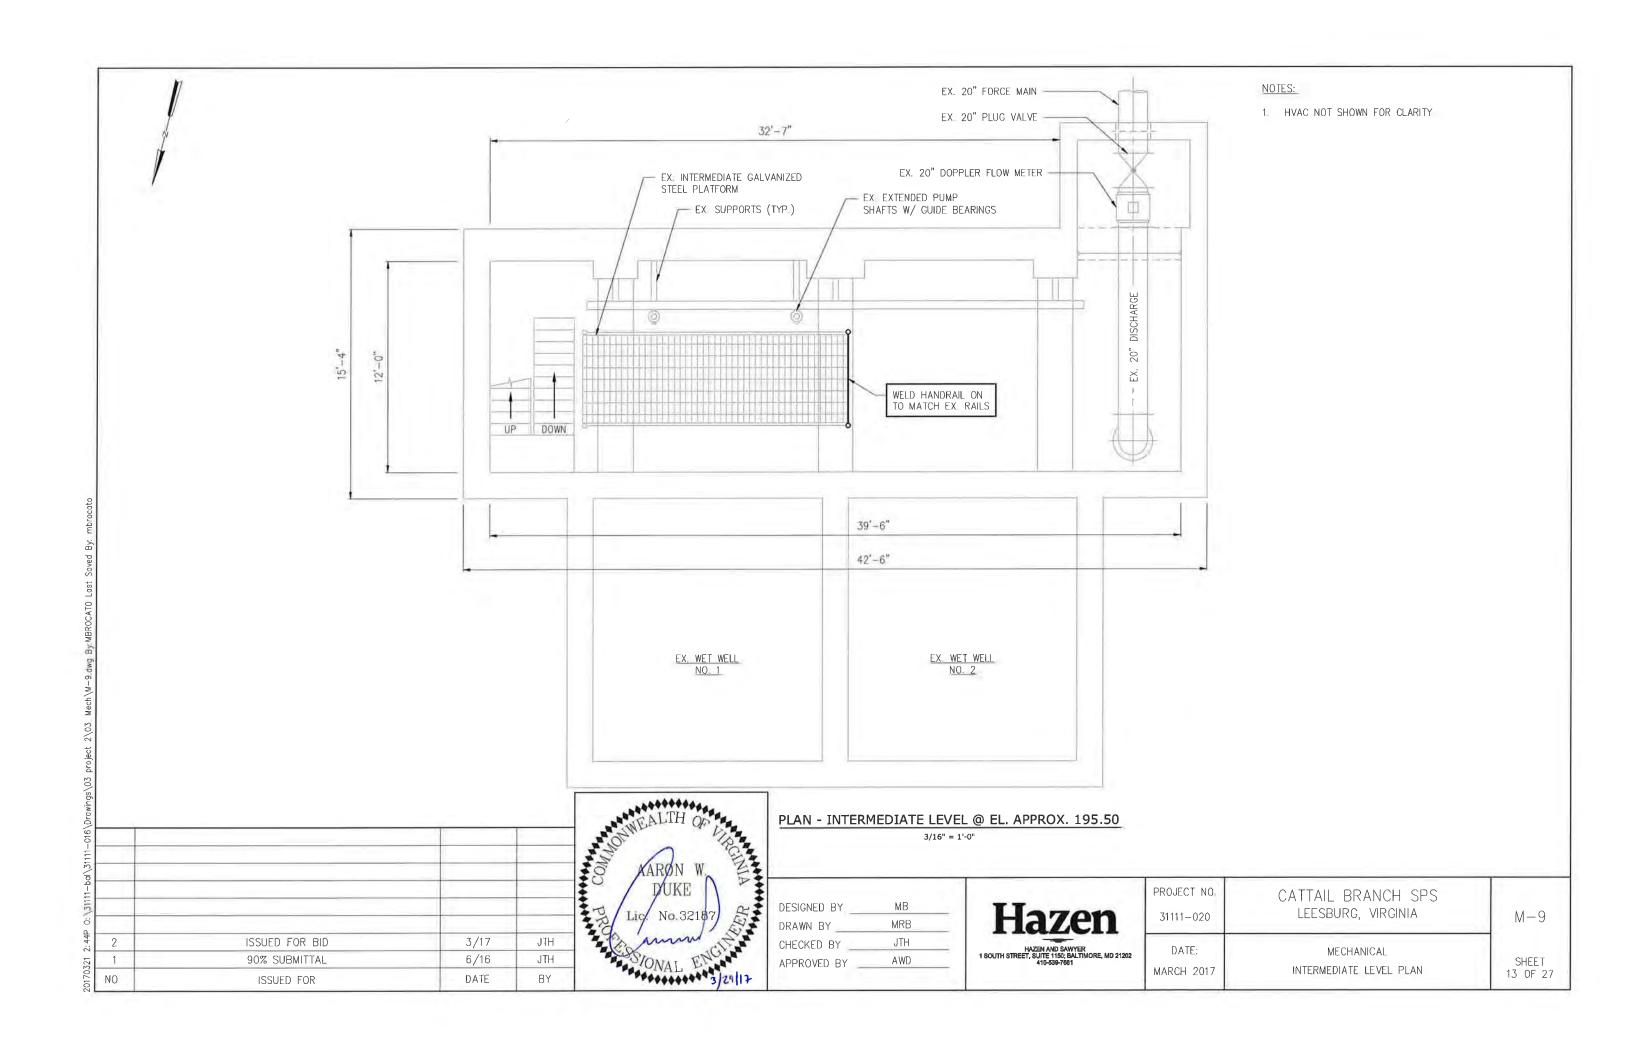


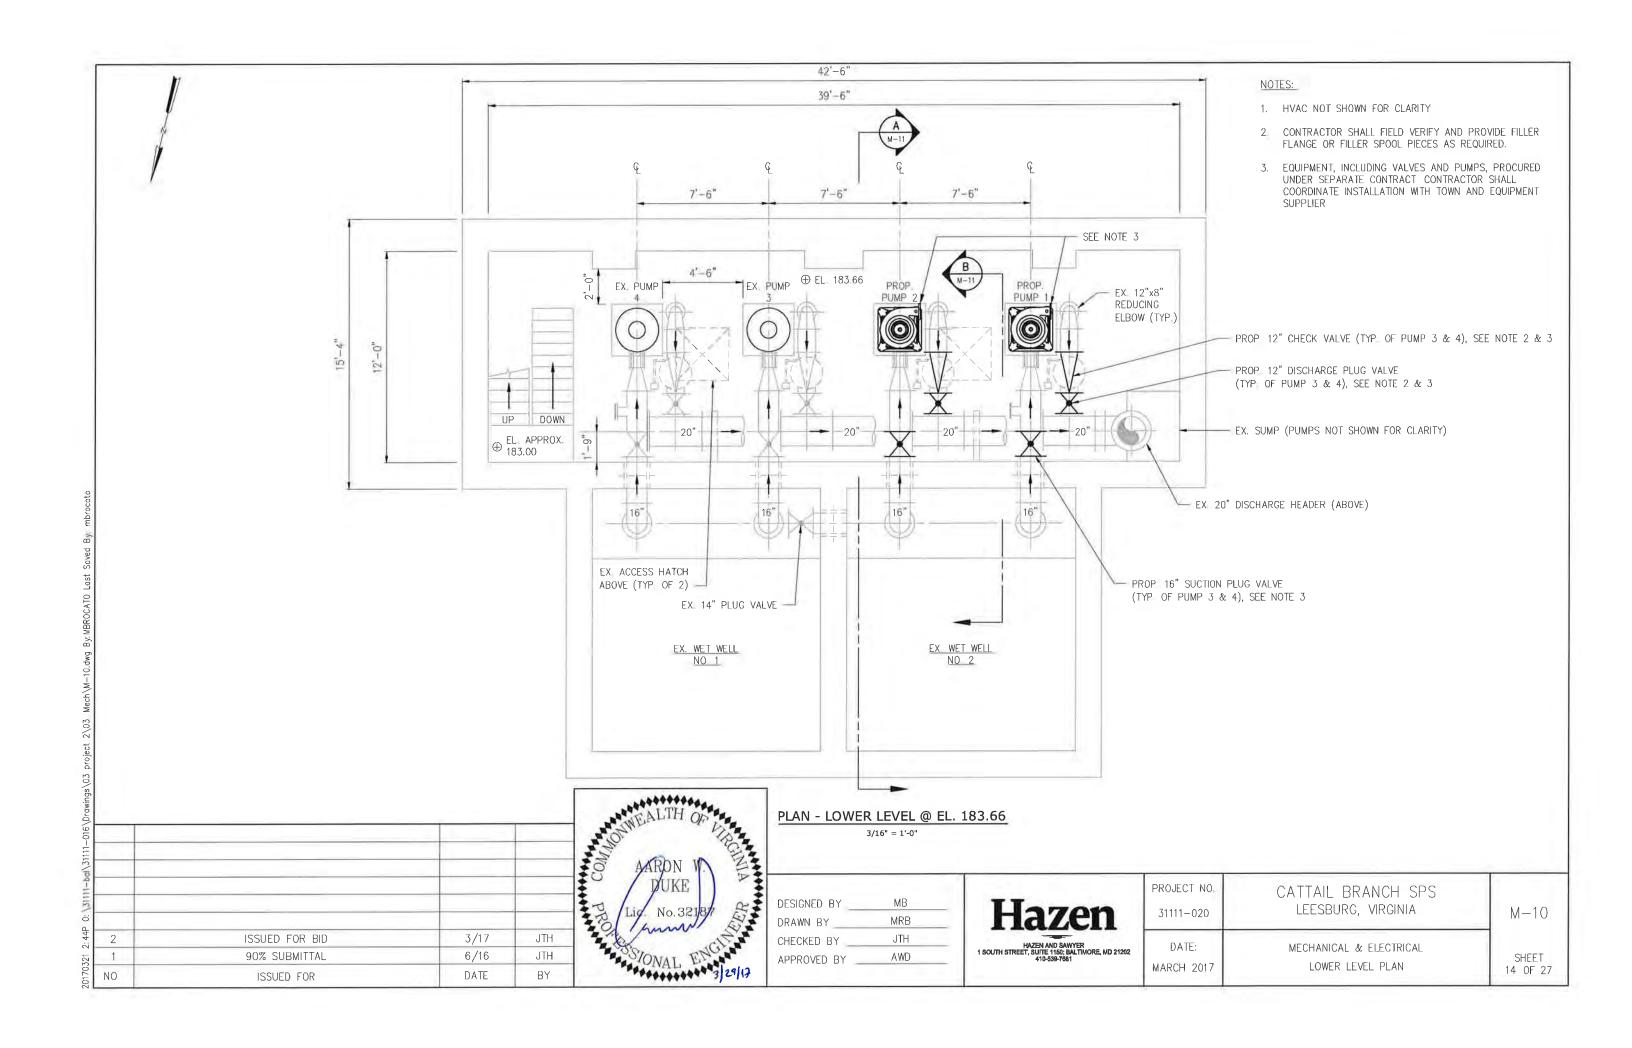

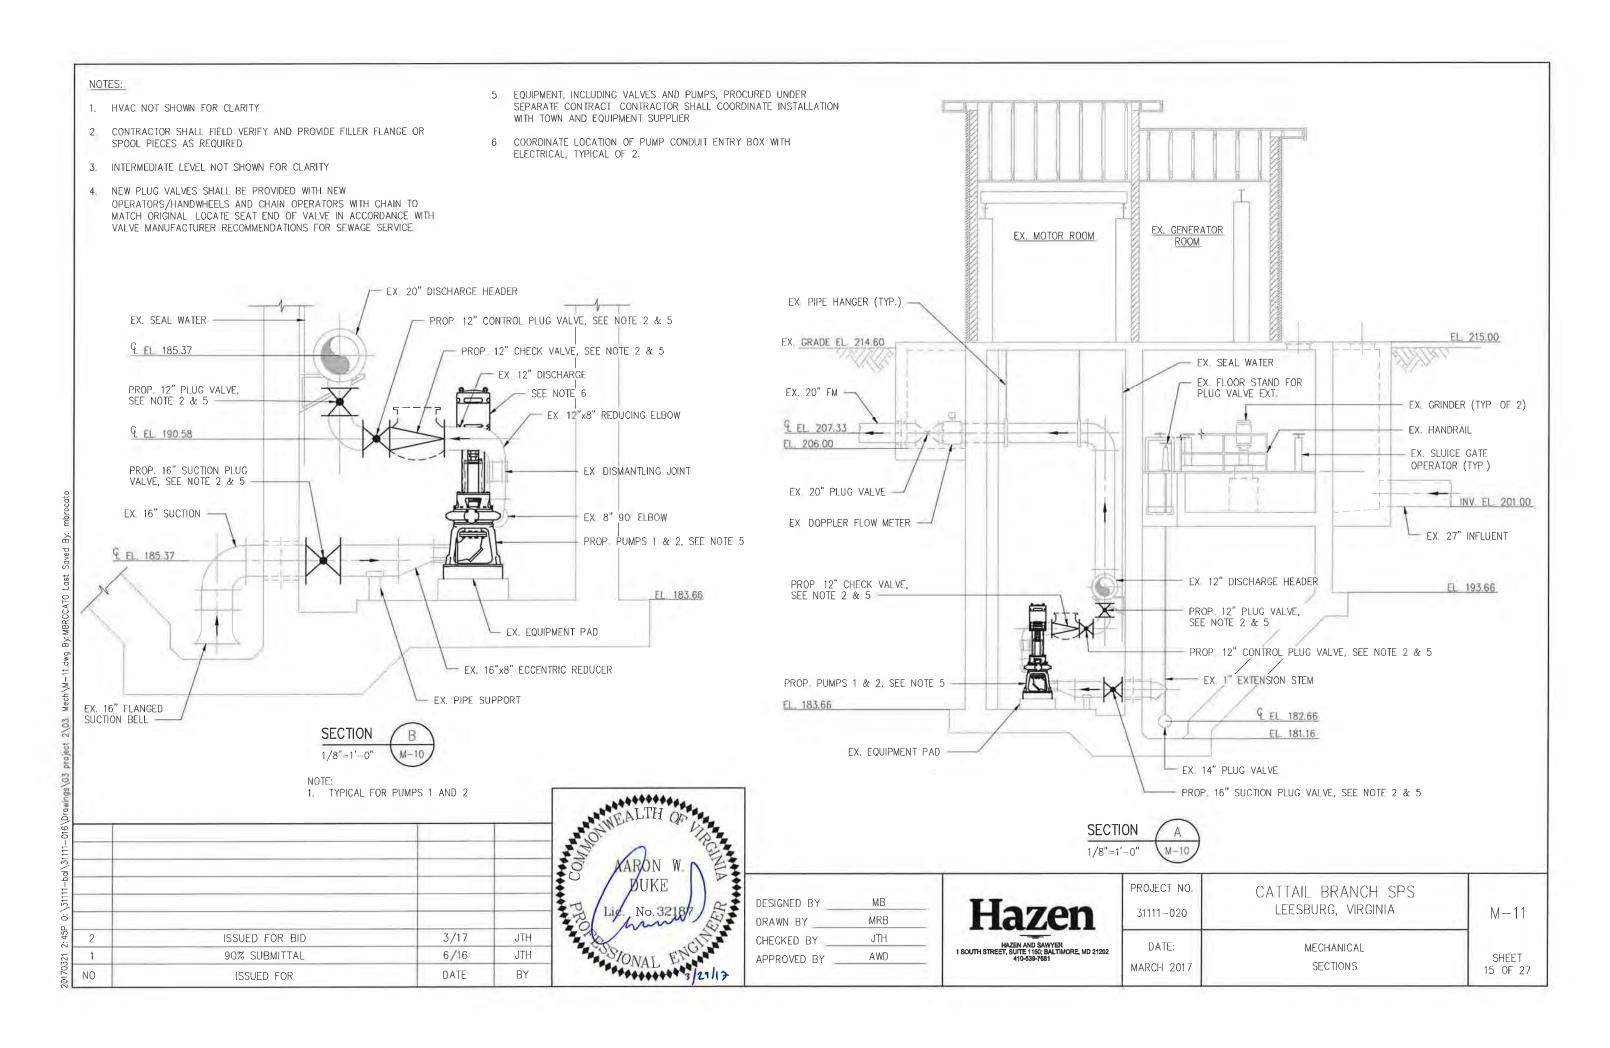

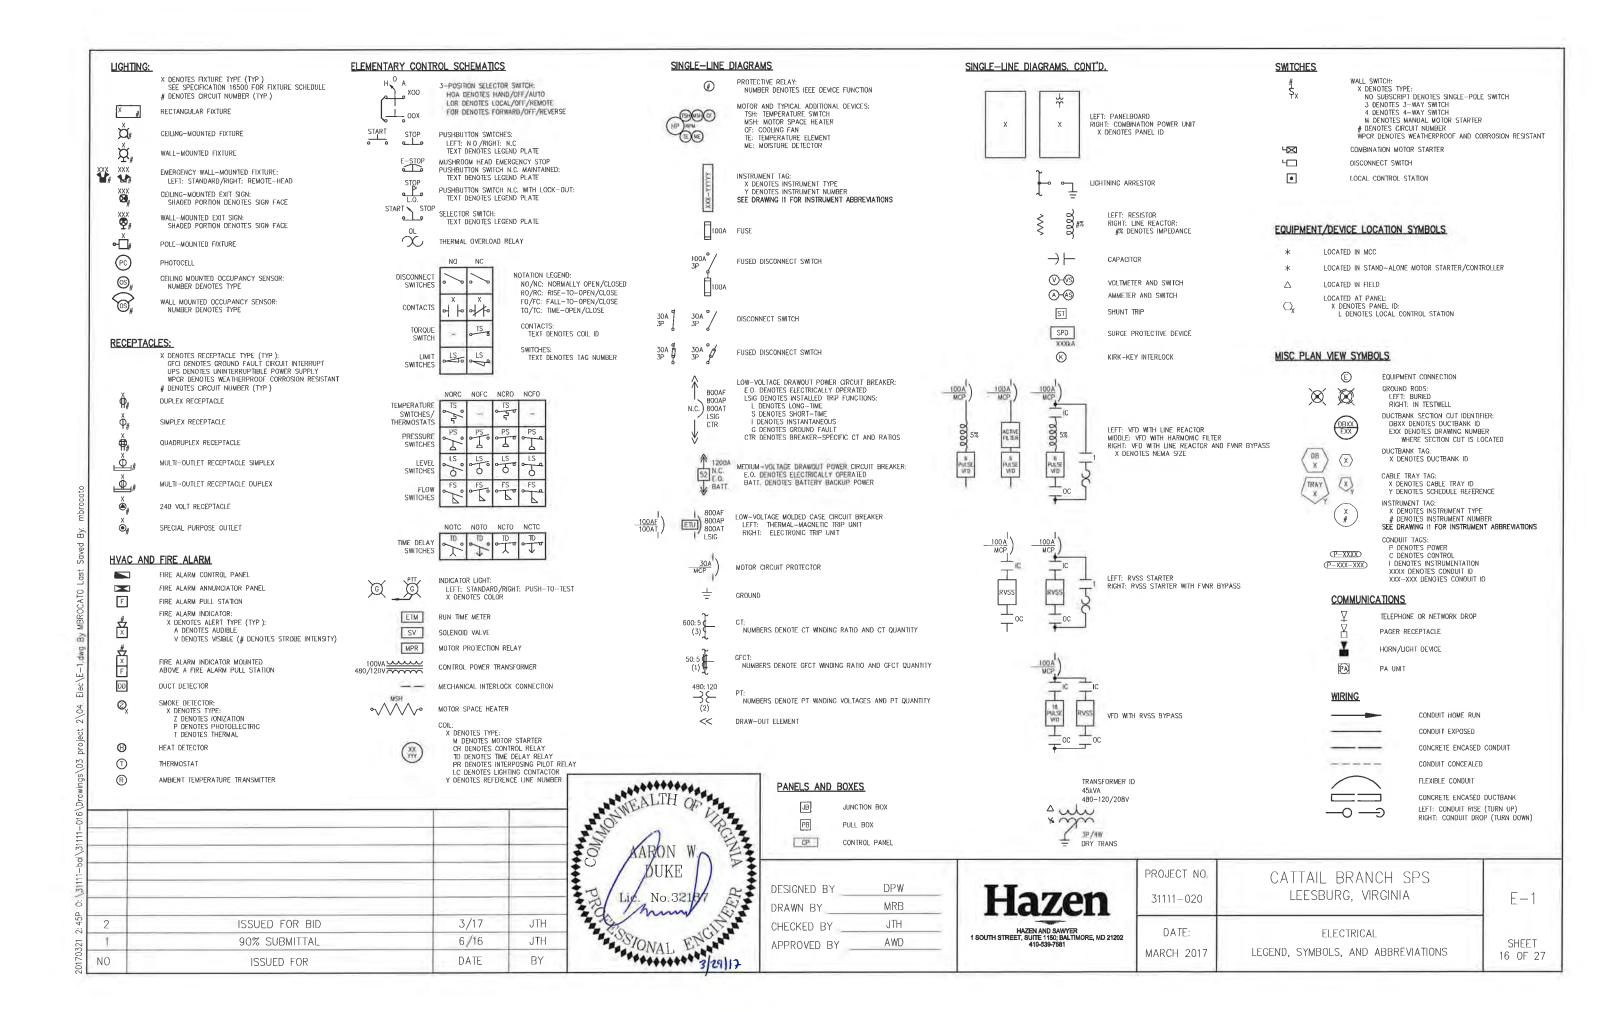

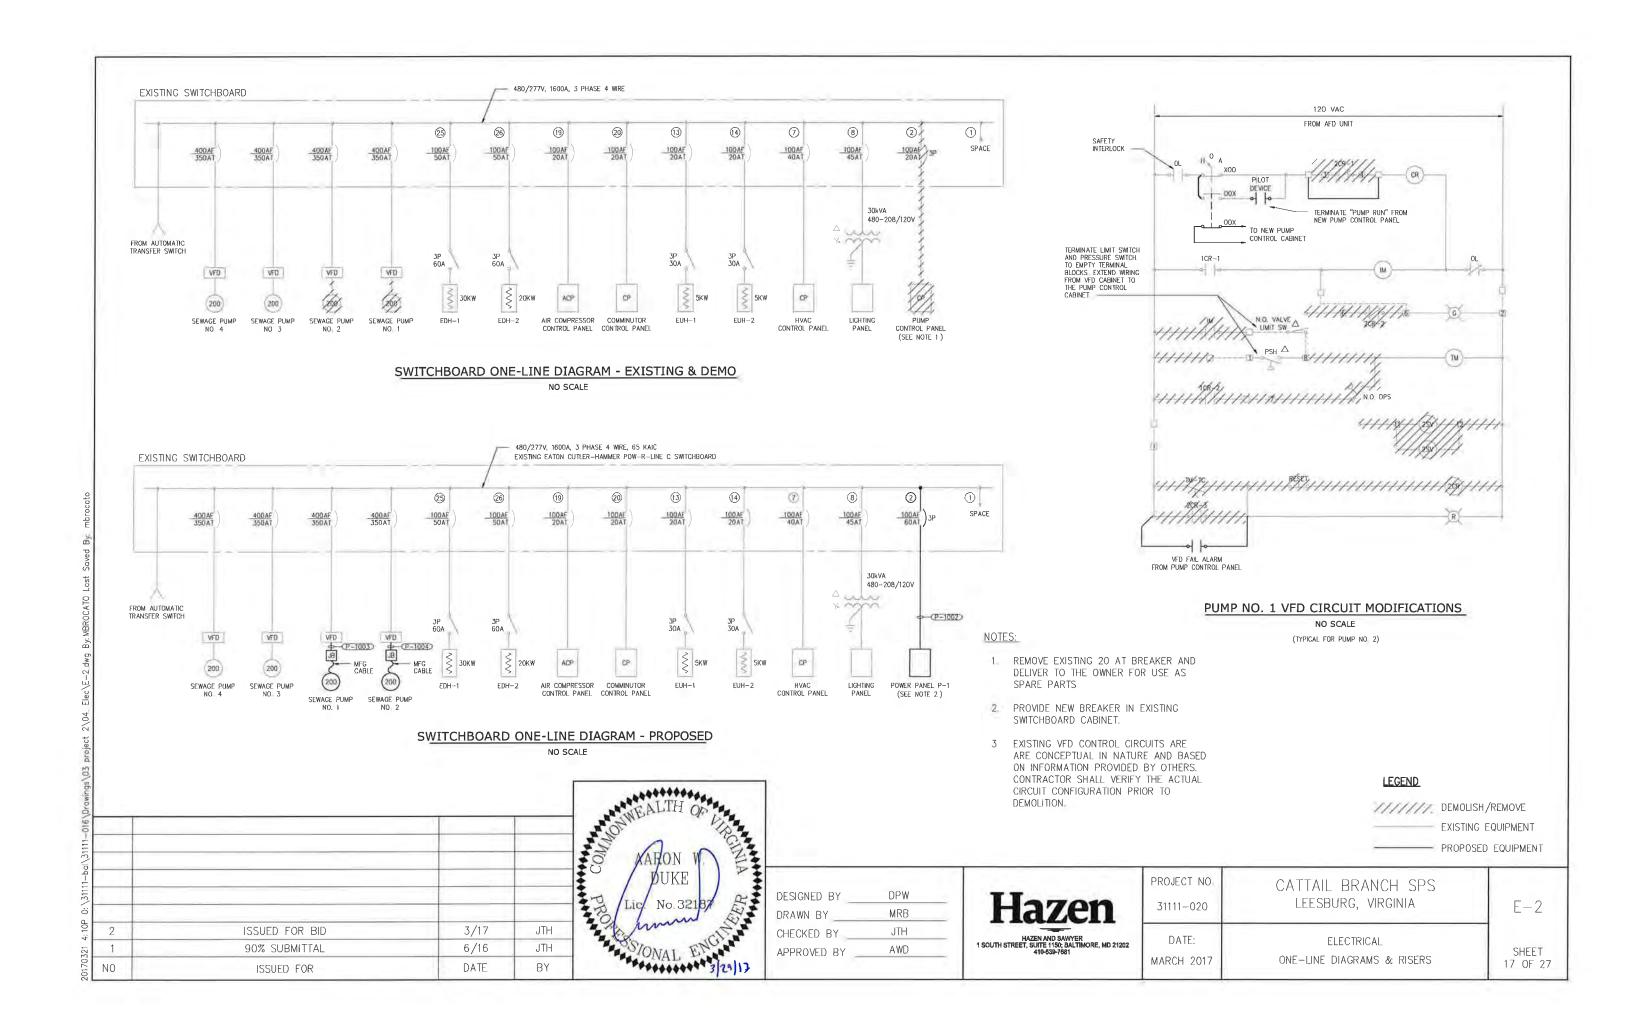

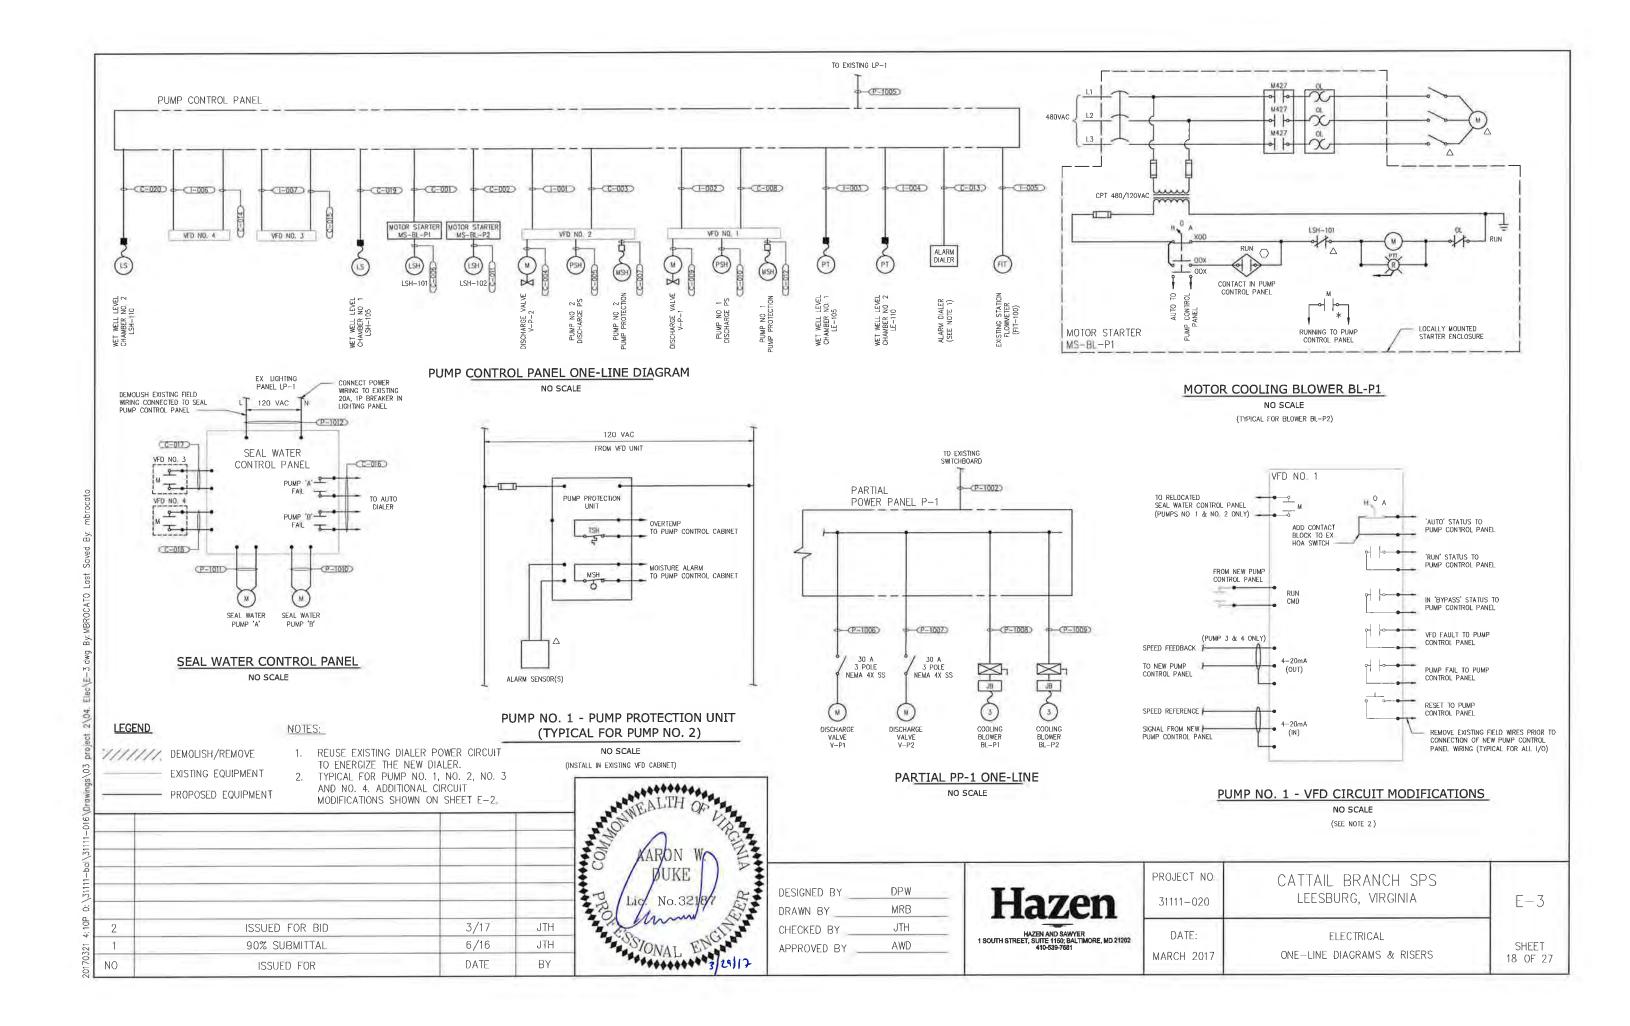

480/277 VOLTS 3 PHASE, 4 WIRE POWER PANEL P1 MAIN BREAKER 60 A 3P

TYPE: NEMA 12

MOUNT: SURFACE

	DEGG DID TION	, who is	TOID	RIP POLE	NI	VOI	VOLT-AMPERES		
MODS	DESCRIPTION	WIRE	TRIP		No.	А	В	С	
	EVICTING DIG CONTROL DANIEL				1	500			
-	EXISTING PLC CONTROL PANEL (TEMPORARY)	P-1013	20	3	3		500		
					5			-	
	PUMP NO. 4 — DISCHARGE				7	300			
-	VALVE V-P-4 (FUTURE)		20	3	9		300		
					11			300	
	PUMP NO. 2 - DISCHARGE				13	300			
- VALVE V-P-2			20	3	15		300		
					17			300	
	PUMP NO. 4 MOTOR COOLING			3	19	150			
-	BLOWER BL-P-4 (FUTURE)		20		21		150		
	BE 1 4 (FOTONE)		-		23			150	
	PUMP NO. 2 MOTOR COOLING				25	150	150		
-	BLOWER BL-P-2	P-1009	20	3	27		150	450	
					29			150	
	00.405		00		31	-			
SF	SPARE		20	3	33				
					35				
	60405		00	_	37	100			
-	SPARE		20	3	39		_		
			100		41			_	

VOLT-AMPERES		VOLT-AMPERES		_T-AMPERES		POLE	TRIP	WIRE	DESCRIPTION	MODS
Α	В	С	No.	POLE	TRIP	WIRE	DESCRIPTION	MOD		
300			2				DUMP NO 7 DISCULADOS			
	300		4	3	20		PUMP NO. 3 - DISCHARGE VALVE V-P-3 (FUTURE)	9		
		300	6				(10.000)			
300			8							
	300		10	3	20	P-1006	PUMP NO. 1 - DISCHARGE VALVE V-P-1	-		
	1	300	21				THE TOTAL CONTRACTOR OF THE TOTAL CONTRACTOR OT THE TOTAL CONTRACTOR OF THE TOTAL CONTRACTOR OT THE TOTAL CONTRACTOR OF THE TO			
150			14				PUMP NO. 3 MOTOR COOLING			
	150		16	3	20		BLOWER	-		
		150	18				BL-P-3 (FUTURE)			
150			20				PUMP NO. 1 MOTOR COOLING			
	150		22	3	20	P-1008	BLOWER	-		
		150	24				BL-P-1			
			26							
	-		28	3	20		SPARE	-		
			30							
-			32							
	9.	_ 14/	34	3	20		SPARE	-		
			36							
-			38							
	-		40	3	20		SPARE	-		
		-	42							

TOTAL 1,400 1,400 900 PHASE TOTAL 2,300 2,300 1,800

900 900 900 TOTAL TOTAL LOAD (VA) 6,400 TOTAL LOAD (A) 8

MODIFIC ATION (MODS) LEGEND:

GFCI - GROUND FAULT CIRCUIT INTERRUPTER

LOD - LOCK-ON DEVICE


LFD - LOCK-OFF DEVICE

NOTES:

65K AIC

100kA SPD

2	ISSUED FOR BID	3/17	JTH
1	90% SUBMITTAL	6/16	JTH
VO	ISSUED FOR	DATE	BY

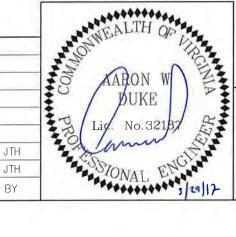


DESIGNED BY	DPW
DRAWN BY	MRB
CHECKED BY	JTH
APPROVED BY	AWD

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LICELLEI
HAZEN AND SAWYER
1 SOUTH STREET, SUITE 1150; BALTIMORE, MD 21202 410-539-7681

PROJECT NO 31111-020	CATTAIL BRANCH SPS LEESBURG, VIRGINIA	E-4
DATE:	ELECTRICAL	SHEET
MARCH 2017	POWER PANEL SCHEDULE	19 OF 27

CONDUIT NO.	SIZE	FROM	ТО	C ONDUC TORS	REMARKS
C-001	3/4"	CONTROL PANEL MS-BL-P1	PUMP CONTROL PANEL	8#14, 1#14 GND	2 SPARE
C-002	3/4"	CONTROL PANEL MS-BL-P2	PUMP CONTROL PANEL	8#14, 1#14 GND	2 SPARE
C-003	1"	PUMP NO. 2 VFD CABINET	PUMP CONTROL PANEL	34#14, 1#14 GND	6 SPARE
C-004	3/4"	PUMP NO. 2 VFD CABINET	DISCHARGE VALVE V-P-2	12#14, 1#14 GND	
C-005	3/4"	PUMP NO. 2 VFD CABINET	DISCHARGE PRESSURE SWITCH PSH-102	3#14, 1#14 GND	
C-006	3/4"	CONTROL PANEL MS-BL-P1	FLOAT SWITCH LSH-101	2#14, 1#14 GND	
C-007	1"	PUMP NO. 2 VFD CABINET	PUMP NO. 2 (MSH)	VENDOR CABLE	PUMP (MSH/TSH) SENSORS
C-008	1"	PUMP NO. 1 VFD CABINET	PUMP CONTROL PANEL	34#14, 1#14 GND	6 SPARE
C-009	3/4"	PUMP NO. 1 VFD CABINET	DISCHARGE VALVE V-P-1	12#14, 1#14 GND	
C-010	3/4"	PUMP NO. 1 VFD CABINET	DISCHARGE PRESSURE SWITCH PSH-101	3#14, 1#14 GND	
C-011	3/4"	CONTROL PANEL MS-BL-P2	FLOAT SWITCH LSH-102	2#14, 1#14 GND	
C-012	1"	PUMP NO. 1 VFD CABINET	PUMP NO. 1 (MSH)	VENDOR CABLE	PUMP (MSH/TSH) SENSORS
C-013	18	ALARM DIALER	PUMP CONTROL CABINET	24#14, 1#14 GND	4 SPARE
C-014	19	PUMP NO. 4 VFD CABINET	PUMP CONTROL CABINET	34#14, 1#14 GND	6 SPARE
C-015	1"	PUMP NO. 3 VFD CABINET	PUMP CONTROL CABINET	34#14, 1#14 GND	6 SPARE
C-016	3/4"	SEAL WATER CONTROL PANEL	AUTO DIALER	4 #14, 1#14 GND	
C-017	3/4"	PUMP NO. 3 VFD CABINET	SEAL WATER CONTROL PANEL	2 #14, 1#14 GND	
C -018	3/4"	PUMP NO_ 4 VFD CABINET	SEAL WATER CONTROL PANEL	2 #14, 1#14 GND	
C-019	3/4"	PUMP CONTROL CABINET	LEVEL SWITCH LSH-105	2 #14, 1#14 GND	
C-020	3/4"	PUMP CONTROL CABINET	LEVEL SWITCH LSH-110	2 #14, 1#14 GND	
I-001	1"	PUMP NO. 2 VFD CABINET	PUMP CONTROL CABINET	2-(2/C#16 TSH), 1#14 GND	
I-002	1"	PUMP NO. 1 VFD CABINET	PUMP CONTROL CABINET	2-(2/C#16 TSH), 1#14 GND	
I-003	3/4"	PUMP CONTROL CABINET	PRESSURE TRANSDUCER PT-1	2/C#16 TSH, 1#14 GND	
1-004	3/4"	PUMP CONTROL CABINET	PRESSURE TRANSDUCER PT-2	2/C#16 TSH, 1#14 GND	
1-005	3/4"	PUMP CONTROL CABINET	EXISTING FLOW TRANSMITTER	2/C#16 TSH, 1#14 GND	
I-006	1"	PUMP NO. 4 VFD CABINET	PUMP CONTROL PANEL	2-(2/C#16 TSH), 1#14 GND	
I-007	1"	PUMP NO. 3 VFD CABINET	PUMP CONTROL PANEL	2-(2/C#16 TSH), 1#14 GND	

2	ISSUED FOR BID	3/17	JTH
1	90% SUBMITTAL	6/16	JTH
NO	ISSUED FOR	DATE	BY

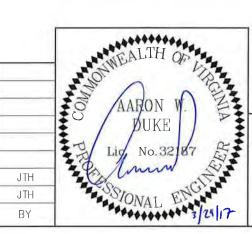


DPW	
MRB	
JTH	
AWD	
	MRB JTH

T	Inmos
I	1dZEII
	HATTH AND OAMOUT
1 SOUTH S	HAZEN AND SAWYER TREET, SUITE 1150; BALTIMORE, MD 21202 410-539-7681

PROJECT NO. 31111-020	CATTAIL BRANCH SPS LEESBURG, VIRGINIA	E-5
DATE:	ELECTRICAL	SHEET
MARCH 2017	CONTROL SCHEDULE	20 OF 2

CONDUIT NO.	SIZE	FROM	ТО	C ONDUC TORS	REMARKS
P-1002	1" C	EXISTING SWITCHBOARD	POWER PANEL P-1	4-#6, 1#10 GND	
P-1003	4" C	PUMP NO. 1 VFD	PUMP NO. 1	VENDOR SUPPLIED CABLE	VIA JUNCTION BOX.
P-1004	4" C	PUMP NO. 2 VFD	PUMP NO. 2	VENDOR SUPPLIED CABLE	VIA JUNCTION BOX.
P-1005	3/4" C	EXISTING LIGHTING PANEL LP-1	NEW PUMP CONTROL PANEL	3#12, 1#12 GND	
P-1006	3/4" C	POWER PANEL P-1	DISCHARGE VALVE V-P-1	3#12, 1#12 GND	VIA DISCONNECT SWITCH
P-1007	3/4" C	POWER PANEL P-1	DISCHARGE VALVE V-P-2	3#12, 1#12 GND	VIA DISCONNECT SWITCH
P-1008	3/4" C	POWER PANEL P-1	COOLING BLOWER BL-P-1	3#12, 1#12 GND	VIA MOTOR STARTER
P-1009	3/4" C	POWER PANEL P-1	COOLING BLOWER BL-P-2	3#12, 1#12 GND	VIA MOTOR STARTER
P-1010	3/4" C	SEAL WATER CONTROL PANEL	SEAL WATER PUMP 'A'	2#12, 1#12 GND	
P-1011	3/4" C	SEAL WATER CONTROL PANEL	SEAL WATER PUMP 'B'	2#12, 1#12 GND	
P-1012	3/4" C	EXISTING LIGHTING PANEL LP-1	SEAL WATER CONTROL PANEL	2#12, 1#12 GND	
P-1013	3/4" C	POWER PANEL P1	EXISTING PUMP CONTROL PANEL	2#12, 1#12 GND	TEMPORARY


-			
2	ISSUED FOR BID	3/17	JTH
1	90% SUBMITTAL	6/16	JTH
NO	ISSUED FOR	DATE	BY

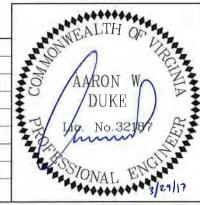



DESIGNED BY	DPW	
DRAWN BY	MRB	
CHECKED BY	JTH	
APPROVED BY	AWD	


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HAZEN AND SAWYER 1 SOUTH STREET, SUITE 1150; BALTIMORE, MD 21202 410-539-7681

PROJECT NO. 31111-020	CATTAIL BRANCH SPS LEESBURG, VIRGINIA	E-6
DATE:	ELECTRICAL	SHEET
MARCH 2017	POWER SCHEDULE	21 OF 27

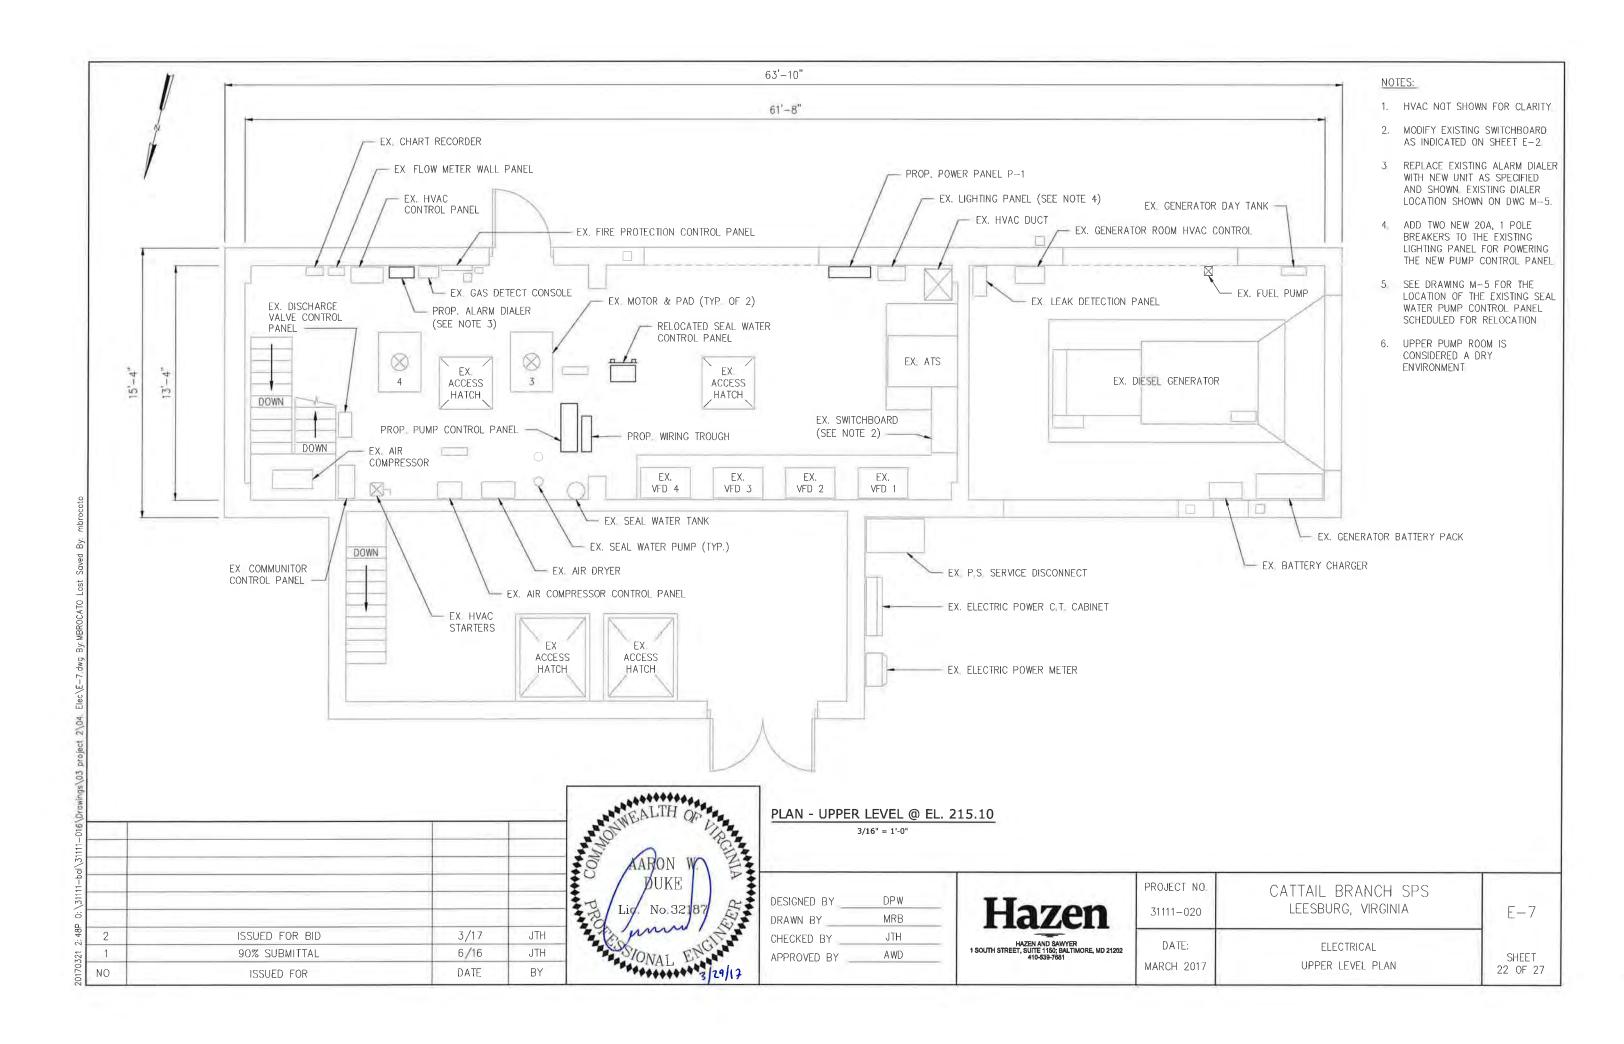

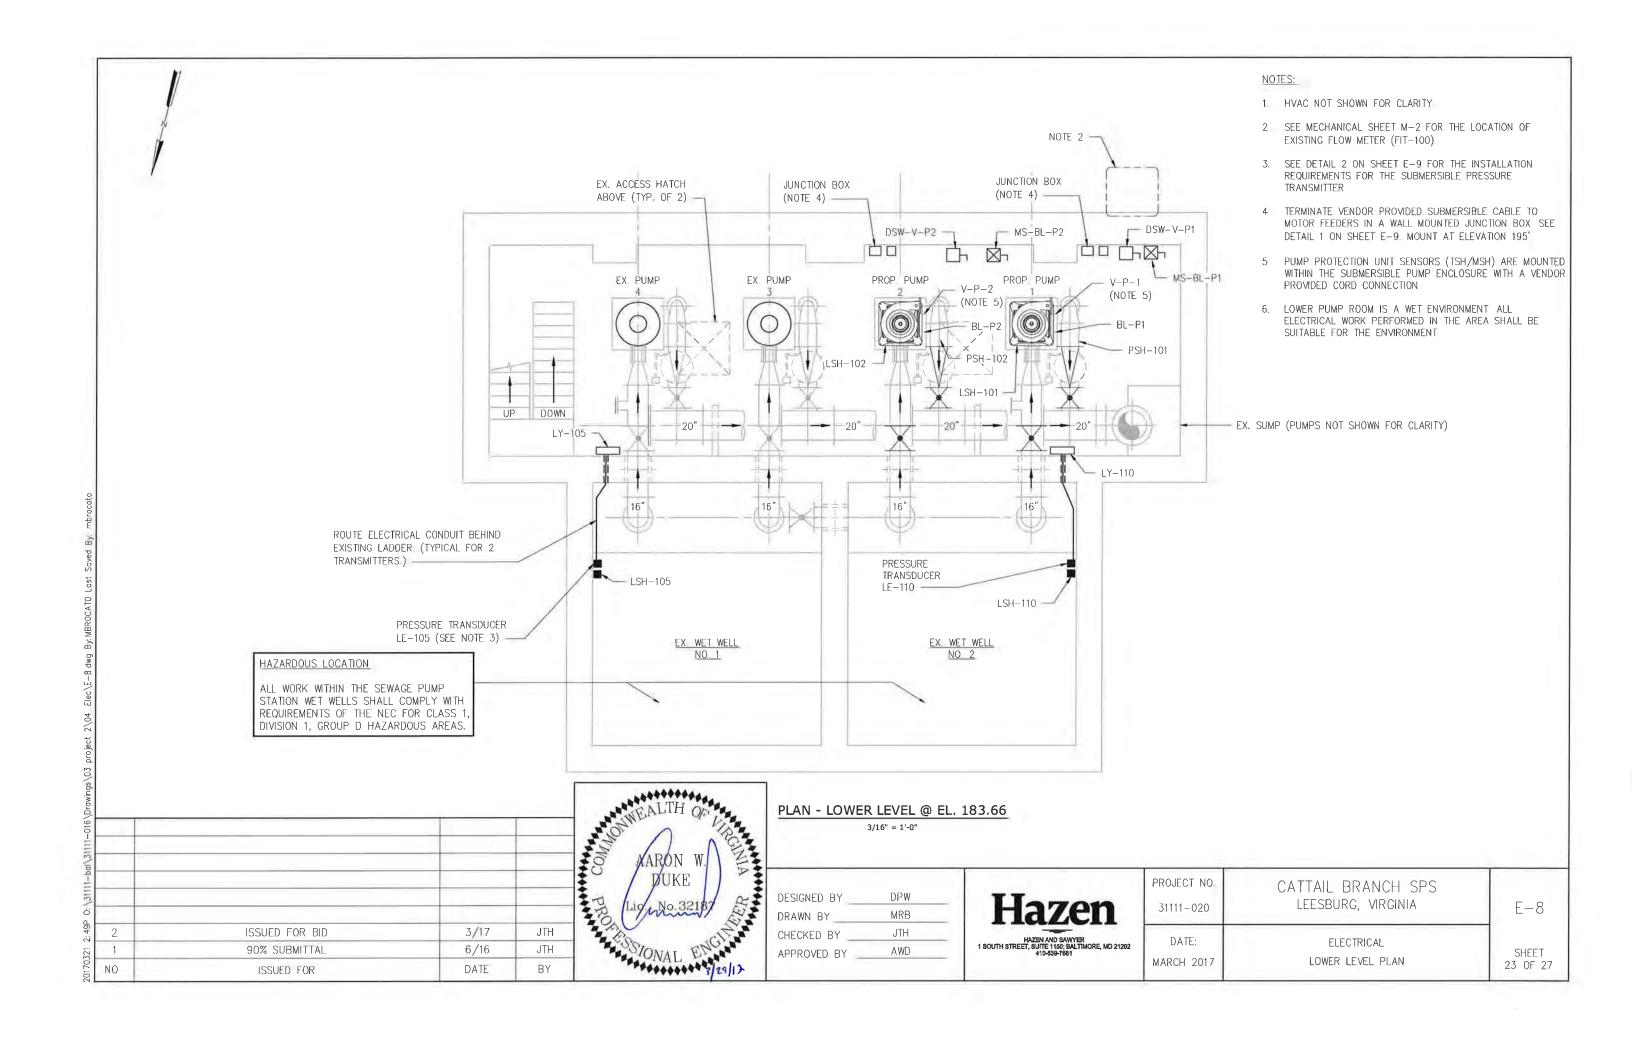

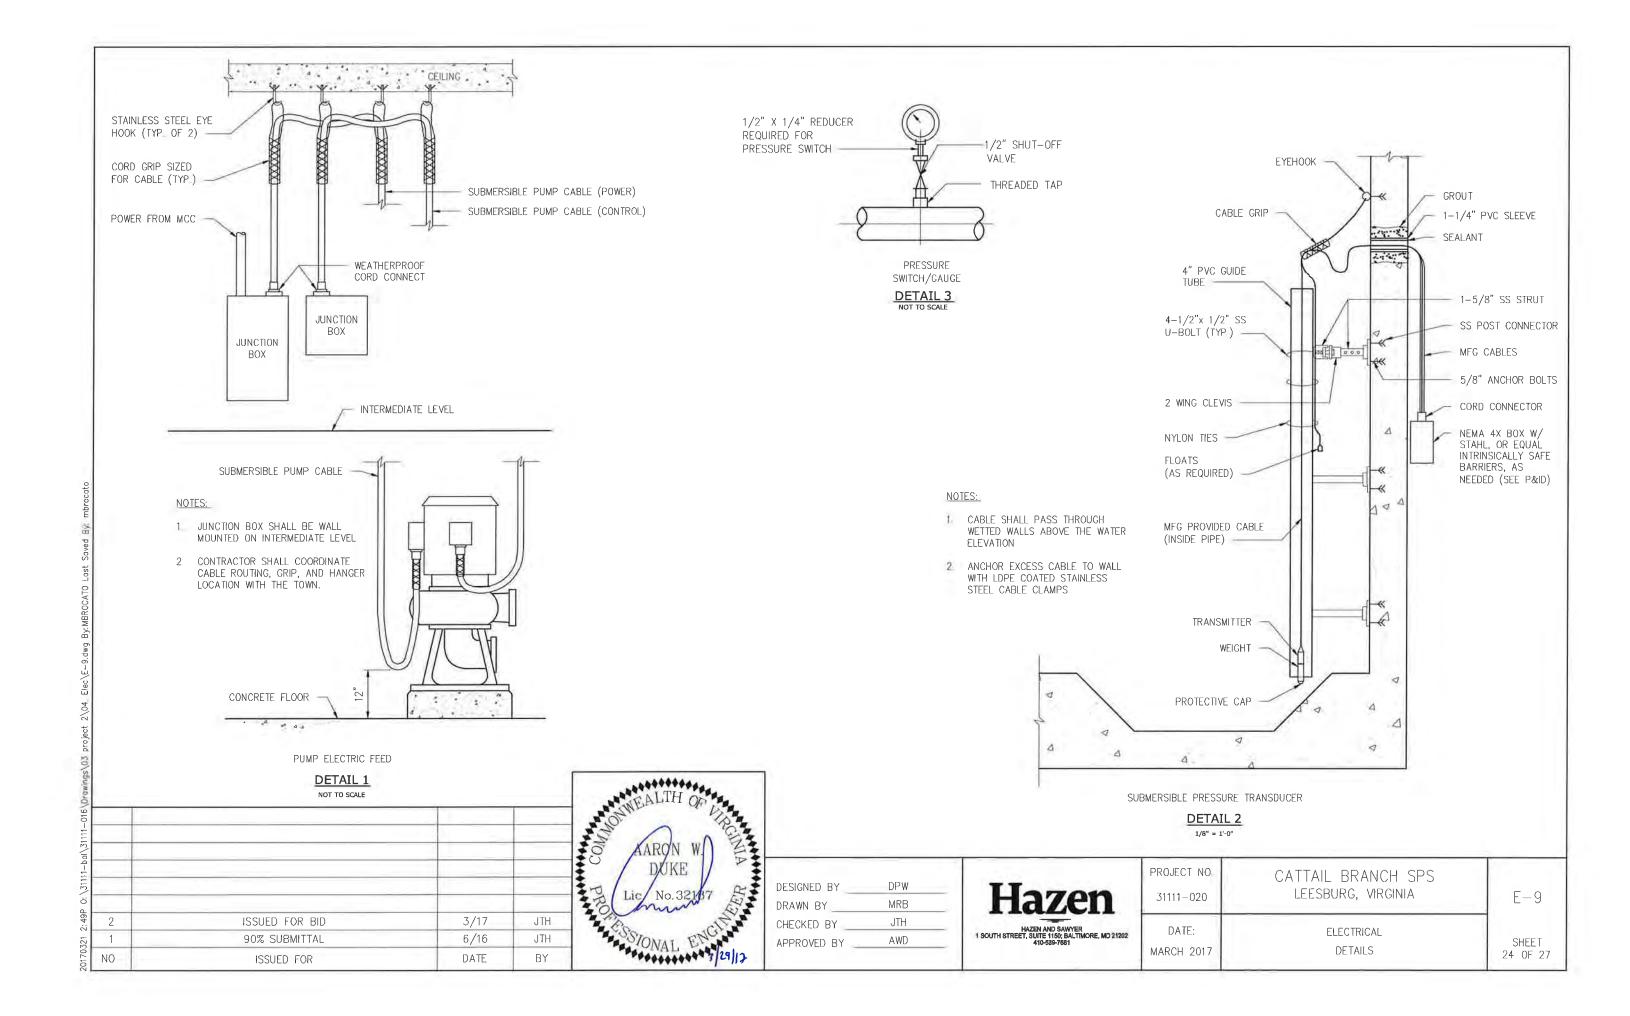

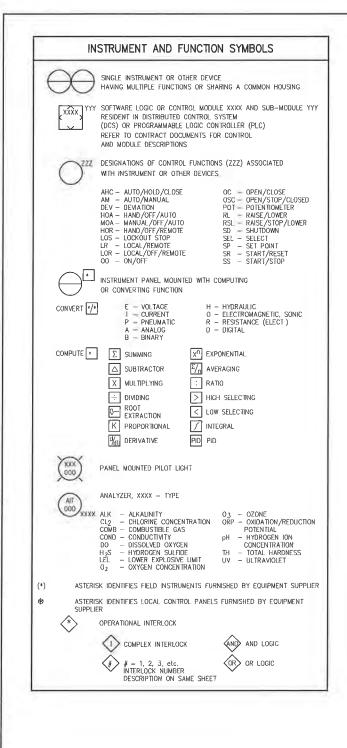


INSTRUMENT AND FUNCTION SYMBOLS, CONT'D				
	PRIMARY LOCATION NORMALLY ACCESSIBLE TO OPERATOR	FIELD MOUNTED	AUXILLARY LOCATION NORMALLY ACCESSIBLE TO OPERATOR	NORMALLY INACCESSIBLE DR BEHIND THE PANEL DEVICES OR FUNCTIONS
FIELD/PANEL EQUIPMENT	XXX 000	(XXX)	XXX 000	XXX 000
SHARED DISPLAY, SHARED CONTROL (OIT)	XXX	XXX 000	XXX 000	XXX
PROGRAMMABLE LOGIC CONTROLLER	, xxx, , , , , , , , , , , , , , , , ,	(xxx)	(000)	XXX QOD
SUPERMSORY COMPUTER FUNCTION (HMI/SERVER)	ABC 12345	ABC \(12345 \)	ABC 12345	ABC 12345


	INSTRUMENT SYMBOLS						
MAGNETIC FLOW METER	VENTURI FLOW TUBE	TURBINE FLOW METER	ROTAMETER	ULTRASONIC FLOW METER	ADDLE WHEEL FLOW METER	VORTEX FLOW METER	POSITIVE DISPLACEMENT FLOW METER
PITOT TUBE	PARSHALL FLUME	WEIR	ORIFICE PLATE	STRAIGHTENING VANES		U SUBMERSIBLE LEVEL SENSOR	
TAPPED RING SEAL	DIAPHRAGM SEAL	FULL LINE RING SEAL	VALVED TAP	RTD AND THERMOWELL	2 2 2 RADAR LEVEL SENSOR (UNCUIDED)	RADAR LEVEL SENSOR (CUIDED)	CAPACITANCE LEVEL SENSOR
SB SIGNAL BOOSTER	123 SEQUENTIAL EQUIPMENT	ANALOG INPUT	ANALOG OUTPUT	DIGITAL INPUT	DIGITAL OUTPUT		

		INSTRUMENT/D	EVICE IDENTIFICATI	ION LETTERS		
	FIRST-L	ETTER	SUCCEEDING-LETTERS			
	MEASURED OR INITIATING VARIABLE	MODIFIER	READOUT OR PASSIVE FUNCTION	OUTPUT FUNCTION	MODIFIER	
٨	ANALYSIS		ALARM			
B	BURNER, COMBUSTION					
C				CONTROL	CLOSE, CLOSED	
D		DIFFERENTIAL				
E	VOLTAGE		PRIMARY ELEMENT SENSOR			
F	FLOW RATE	FRACTION RATIO				
G	GAUGE		CLASS, VIEWING DEVICE			
H	HAND				HIGH	
1	ELECTRICAL CURRENT		INDICATE			
d	POWER	SCANE				
K	TIME, TIME SCHEDULE	TIME RATE OF CHANGE		CONTROL STATION		
L	LEVEL		LIGHT		LOW	
M		MOMENTARY			MIDDLE, INTERMEDIATE	
N	TORQUE					
0			ORIFICE, RESTRICTION		OPEN, OPENED	
P	PRESSURE, VACUUM		TEXT POINT CONNECTION			
0	QUANTITY	INTEGRATE, TOTALIZE				
B.	RUN		RECORD & STORE	REPORT		
5	SPEED, FREQUENCY	SAFETY		SWITCH		
1	TEMPERATURE			TRANSMIT		
Ü	MULTIVARIABLE	January 1	MULTIFUNCTION	MULTIFUNCTION	MULTIFUNCTION	
٧	VIBRATION, VOLUME MECHANICAL ANALYSIS			VALVE, DAMPER, LOUVER		
W	WEIGHT, FORCE		WELL			
X	FAILURE OR TROUBLE	X AXIS				
۲	EVENT STATE /PRESENCE	Y AXIS		COMPUTE, REVERT, RELAY		
Z	POSITION, DIMENSION	Z AXIS		DRIVER, ACTUATOR, FINAL CONTROL ELEMENT		

	VALVE AND ACT	UATOR SYMBOLS	
GENERIC VALVE	PLUG VALVE	GLOBE VALVE	BALL VALVE
BALL VALVE (3-WAY)	3-WAY VALVE (GENERAL)	PINCH VALVE	COMBINATION VACUUM A
BUTTERFLY VALVE	SWING CHECK VALVE	BALL CHECK VALVE	DIAPHRAGM VALVE
→ H NEEDLE VALVE	ANGLE VALVE	ROTARY VALVE	$\dashv \stackrel{\Gamma}{ abla} dash$
PRESSURE RELEIF OR SAFETY VALVE	VACUUM RELIEF VALVE	PRESSURE-REDUCING REGULATOR	BACKPRESSURE REGULATOR
BACKFLOW PREVENTER	SLUICE GATE	E	STRAINER
BACKFLOW PREVENTER	ELECTRIC ACTUATOR	S) SOLENOID ACTUATOR	PNEUMATIC ACTUATOR
(/P) CTROPNEUMATIC ACTUATO	(/H) LECTROHYDRAULIC ACTUATOF	T HAND WHEEL	₩ HYDRANT
CENTRIFUGAL PUMP			

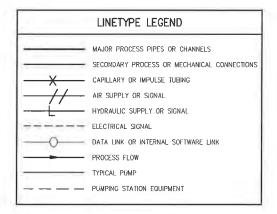


1711/1			
2	ISSUED FOR BID	3/17	JTH
1	90% SUBMITTAL	6/16	JTH
NO	ISSUED FOR	DATE	BY

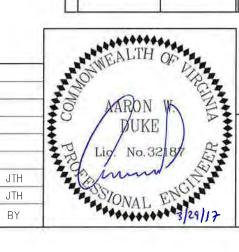


ESIGNED BY	DPW	TT-
DRAWN BY	MRB	На
CHECKED BY	JTH	HAZEN
APPROVED BY	AWD	1 SOUTH STREET, SUIT

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HAZEN AND SAWYER 1 SOUTH STREET, SUITE 1150; BALTIMORE, MD 21202 410-539-7681
110 000 1001


PROJECT NO 31111-020	CATTAIL BRANCH SPS LEESBURG, VIRGINIA	I-1
DATE: MARCH 2017	INSTRUMENTATION LEGEND, SYMBOLS, AND ABBREVIATIONS	SHEET 25 OF 27

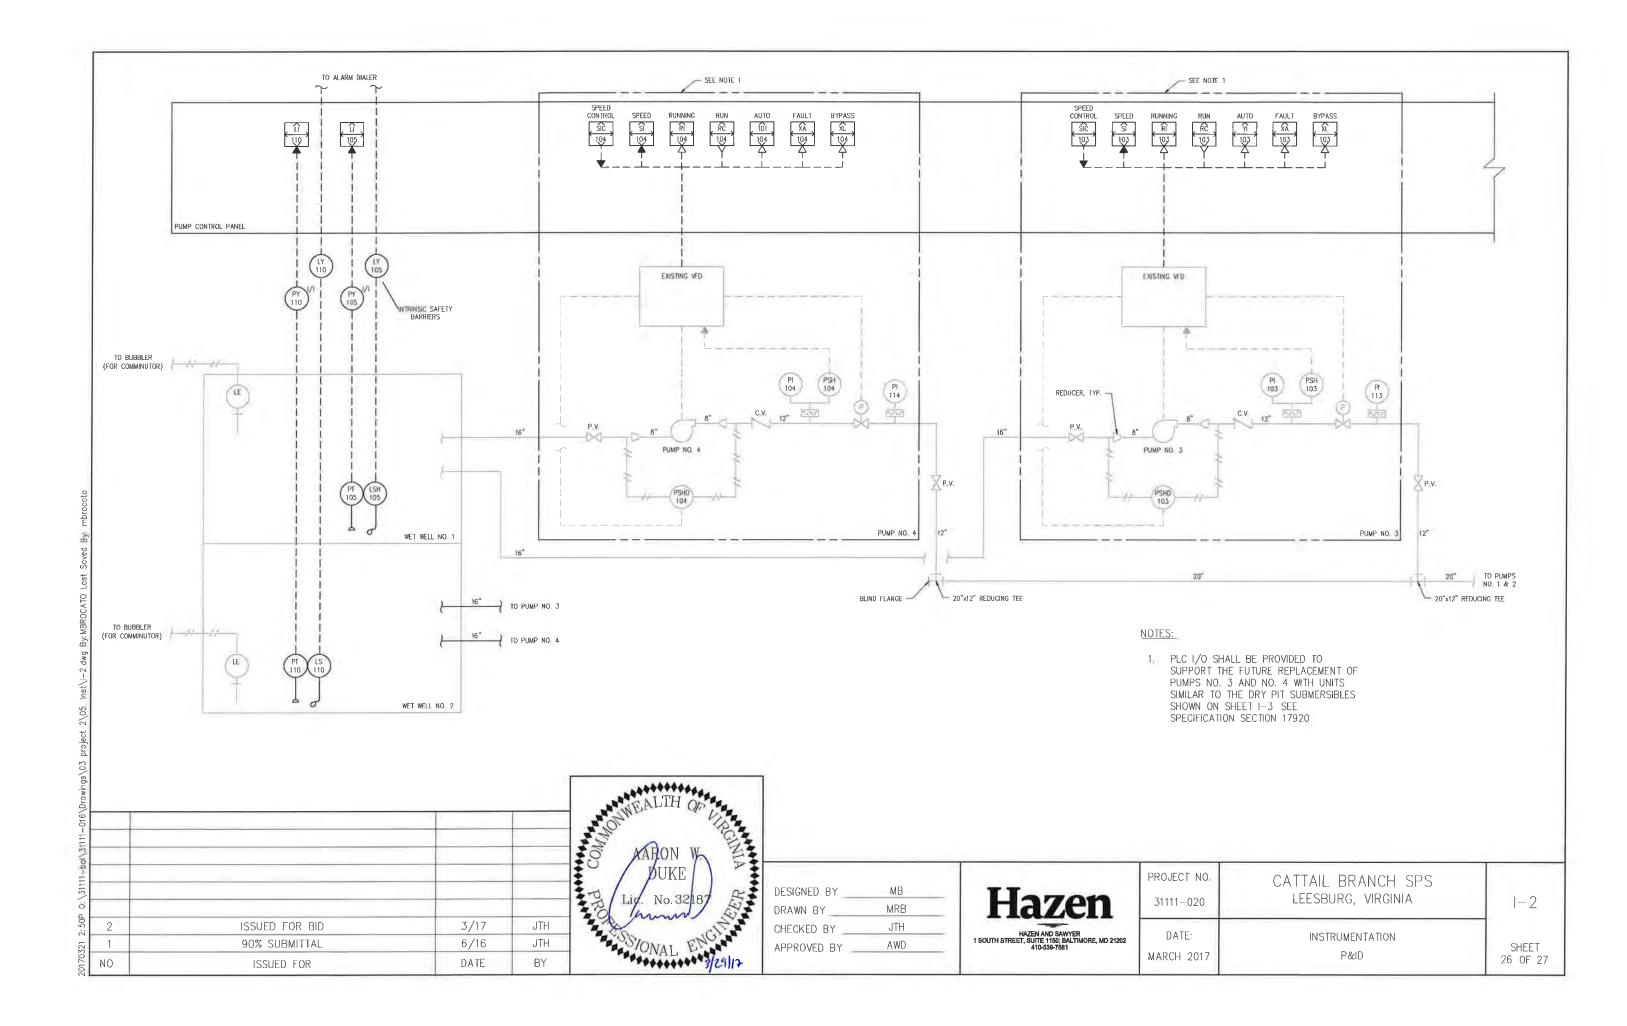

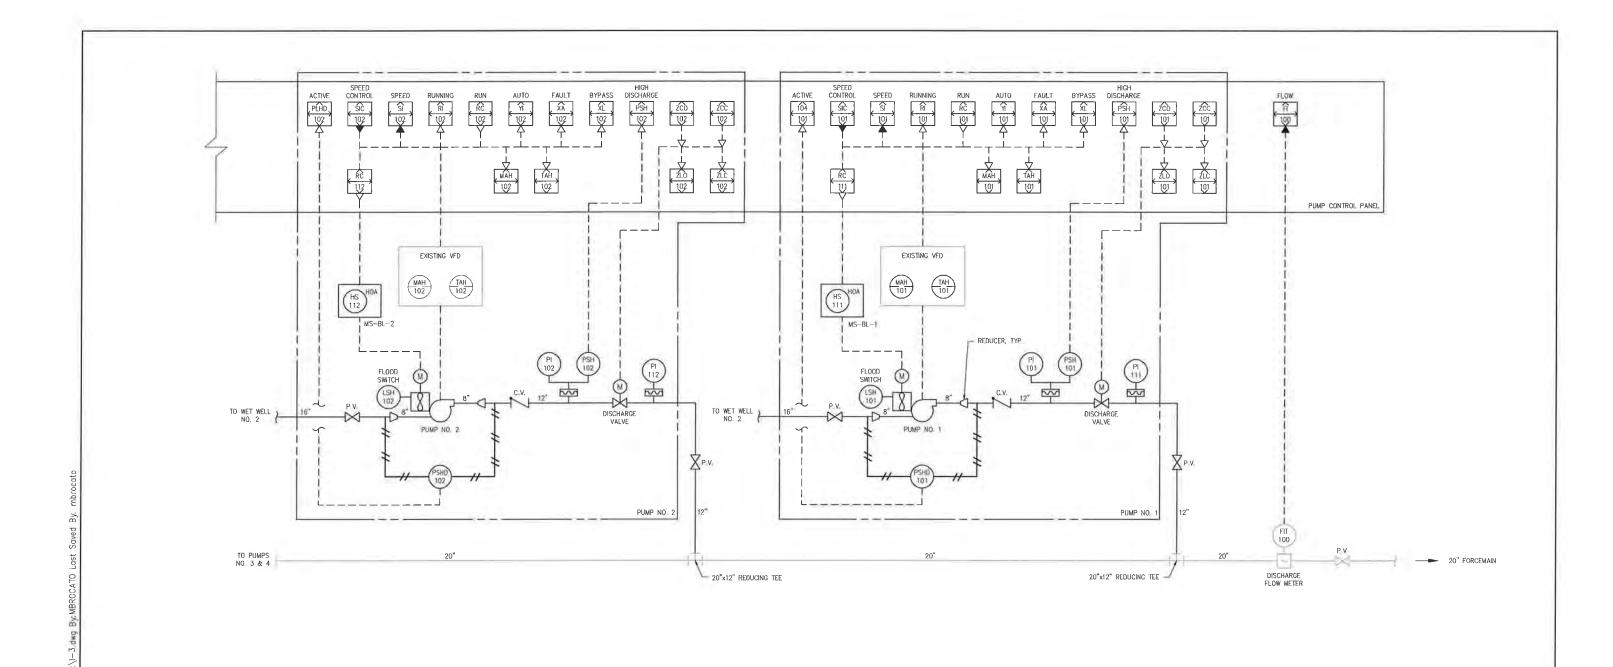

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				900

2	ISSUED FOR BID	3/17	JTH	1
1	90% SUBMITTAL	6/16	JTH	
NO	ISSUED FOR	DATE	BY	

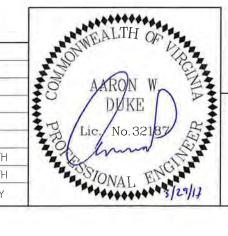

DESIGNED BY	DPW	
DRAWN BY	MRB	
CHECKED BY	JTH	
APPROVED BY	AWD	

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